

CRLCSWA SITE 2 SITE LOCATION MAP

SCALE 1" = 1000'

Contract Drawings For

# CEDAR RAPIDS LINN COUNTY SOLID WASTE AGENCY SITE 2

2024 LANDFILL GAS SYSTEM IMPROVEMENTS

Marion, Iowa

Issued for Bid

HDR Project No. 10383401

November 2023

#### INDEX OF DRAWINGS

GENERAL 00G000 00G001	COVER SHEET GENERAL NOTES, LEGEND AND ABBREVIATIONS
CIVIL	
00C101	EXISTING GAS COLLECTION SYSTEM PLAN
00C102	PROPOSED GAS COLLECTION SYSTEM PLAN
00C103	PROPOSED GAS COLLECTION HEADER PROFILE
00C501	VERTICAL WELL DETAILS
00C502	TRENCH AND COLLECTION SYSTEM DETAILS
00C503	VALVE GROUP DETAILS
00C504	VALVE GROUP AND WELLHEAD DETAILS
00C505	LANDFILL GAS PIPELINE AND LEACHATE EXTRACTION PAD DETAILS
00C506	I FACHATE RECIRCUI ATION AND CONDENSATE PUMP STATION DETAILS



I HEREBY CERTIFY THAT THIS ENGINEERING DOCUMENT WAS PREPARED BY ME OR UNDER MY DIRECT PERSONAL SUPERVISION AND THAT I AM A DULY LICENSED PROFESSIONAL ENGINEER UNDER THE LAWS OF THE STATE OF IOWA

KATIE KINLEY, P.E.

11.21.23 (DATE)

MY LICENSE RENEWAL DATE IS DECEMBER 31, 2023.

PAGES OR SHEETS COVERED BY THIS SEAL:

ALL CIVIL (C) SHEETS; ALL GENERAL (G) SHEETS

- 1. INSTALLATION OF VERTICAL LANDFILL GAS WELLS, LANDFILL GAS LATERAL AND HEADER PIPE, TIE-INS, AND APPURTENANCES.
- 2. REDRILLING OF VERTICAL LANDFILL GAS WELLS.
- 3. INSTALLATION OF CONDENSATE PUMP STATION #3
- 4. IMPROVEMENTS TO LEACHATE RECIRCULATION INFRASTUCTURE.
- 5. TRENCH BACKFILL, GRADING, COMPACTING AND SEEDING OF EROSION AND DISTURBED AREAS.


#### **GENERAL NOTES:**


- THIS IS A STANDARD SHEET SHOWING COMMON SYMBOLOGY. ALL SYMBOLS ARE NOT NECESSARILY USED ON THIS PROJECT.
- 2. SCREENING OR SHADING OF WORK IS USED TO INDICATE EXISTING COMPONENTS OR TO DE-EMPHASIZE PROPOSED IMPROVEMENTS TO HIGHLIGHT SELECTED TRADE WORK. REFER TO CONTEXT OF EACH SHEET FOR USAGE.
- 3. SEE SPECIFICATIONS FOR BASIS OF BIDS.
- 4. TOPOGRAPHY AND SITE INFORMATION PROVIDED BY AEROVIEW DATED OCTOBER 16. 2023. BACKGROUND SURVEY WITHIN THE LIMITS OF CONSTRUCTION MAY BE UPDATED IN AREA OF PROPOSED WORK IMMEDIATELY PRIOR TO BORINGS, PIPE INSTALLATION, OR INSTALLATION OF STRUCTURES - SEE SPECIFICATIONS ON CONTRACTOR SURVEYING.
- 5. DO NOT OBSTRUCT LANDFILL SITE ACCESS ROADS PER TECHNICAL SPECIFICATIONS. COORDINATE ALL ROADWAY UTILIZATION, STAGING, ROADWAY CUTS, AND RECONSTRUCTION TO ENSURE CONTINUOUS SITE ACCESS AND ACCESS TO ACTIVE LANDFILL AREAS. SEE SPECIFICATIONS FOR REQUIREMENTS FOR COORDINATION, SEQUENCING, INCLUDING COORDINATION WITH ONGOING LANDFILL OPERATIONS.
- 6. CONFINE ALL WORK TO DESIGNATED LIMITS OF CONSTRUCTION.
- 7. ACCESS OFF OF HIGHWAY 13 TO THE AREA OF WORK WILL BE VIA COUNTY HOME ROAD AND HTE LANDFILL SITE ENTRANCE. LARGE EQUIPMENT SHALL ENTER THROUGH THE BACK GATE OFF OF ECHO HILL ROAD AND WILL BE COORDINATED WITH THE OWNER, AS NEEDED.
- 8. SEE TECHNICAL SPECIFICATIONS ON CONTRACTOR'S RESPONSIBILITY TO LOCATE AND PROTECT UTILITIES NOT DEFINED OR LOCATED BY DIGGER'S HOTLINES OR UTILITY COMPANIES.
- 9. COORDINATES FOR PROPOSED BORINGS AND STRUCTURES MAY BE MODIFIED BASED ON FIELD CONDITIONS AT THE TIME OF INSTALLATION. PRIOR TO BORINGS OR EXCAVATION CONTRACTOR SHALL VERIFY WITH ENGINEER THAT PROPOSED WORK WILL NOT IMPACT EXISTING LANDFILL LINER, CAPPING SYSTEM, LEACHATE CONVEYANCES OR OTHER ENVIRONMENTAL PROTECTION FEATURES. SEE TECHNICAL SPECIFICATIONS.
- 10. EXACT LOCATION OF SOIL STOCKPILES MAY VARY. CONFIRM LOCATIONS PRIOR TO ADDING OR REMOVING SOILS IN THESE STOCKPILES.
- 11. EXACT LOCATIONS OF PIPE AND TRENCHES FOR LATERALS AND HEADERS MAY BE MODIFIED IN FIELD BASED ON SITE CONDITIONS AT THE TIME OF CONSTRUCTION AND TO ENSURE PROPER SLOPES AND ROUTING, AS APPROVED BY THE ENGINEER.
- 12. SEE SPECIFICATIONS ON MANAGING SURFACE WATER DURING CONSTRUCTION, CONTRACTOR TO PROVIDE STORM WATER DIVERSION BERMS AND CONTROLS AS REQUIRED TO PREVENT RUN-ON TO WORK AREAS.
- 13. PROTECT ALL WORK FROM FROSION AND SEDIMENT CAUSED BY THE EXISTING LANDFILL. SEDIMENT ACCUMULATION WITHIN THE WORK AREA SHALL BE REMOVED AT THE CONTRACTOR'S EXPENSE. IT IS THE CONTRACTOR'S RESPONSIBILITY TO ENSURE EROSION CONTROL MEASURES MEET MINIMUM FEDERAL, STATE, AND LOCAL REGULATIONS.
- 14. CONTRACTOR SHALL REMOVE ACCUMULATED SEDIMENT AND DEBRIS FROM CONTROL STRUCTURES (DRAINAGE CHANNELS, CULVERTS, SEDIMENT BASINS, TRAPS, ETC.) FOLLOWING COMPLETION OF THE WORK AND PLACE AT LOCATION APPROVED BY OWNER.
- 15. OBTAIN ALL REQUIRED BORROWED SOIL FROM THE APPROVED SOIL BORROW AREA, UNLESS OTHERWISE DIRECTED. DO NOT BORROW BELOW GRADES IDENTIFIED ON SURVEY GRADE STAKES WITHIN THE BORROW AREA.
- 16. IN ALL CASES, CONTRACTOR SHALL TAKE CARE TO PREVENT DAMAGE TO ESTABLISHED VEGETATION AND FINAL COVER SYSTEM DUE TO CONTRACTOR VEHICLE TRAFFIC. CONTRACTOR SHALL REPAIR ALL VEGETATION AND SOIL DAMAGE (I.E. RUTTING) CAUSED BY CONSTRUCTION ACTIVITIES IN MANNER SUITABLE TO OWNER PRIOR TO COMPLETION OF PROJECT WORK.
- 17. PREVENTION OF STORM WATER INTRUSION IS VITAL INTO THE EXISTING WASTE MASS VIA OPEN TRENCHING OR EXCAVATIONS IS VITAL TO ONGOING LANDFILL OPERATIONS. EMPLOY MEANS NECESSARY TO COMPLETE PROTECT WORK AREAS FROM CONTRIBUTING TO EXCESS LEACHATE GENERATION.
- 18. WHERE DESIGNATED ACCESS ROADS TO CONSTRUCTIONS AREAS ARE NOT SHOWN ON DRAWINGS, COORDINATE PLANNED ACCESS ROUTES WITH OWNER AND ENGINEER AT THE PRE-CONSTRUCTION
- 19. BACKFILL AND FINAL BACKFILL SHALL BE MOISTURE CONDITIONED (AS REQUIRED), PLACED IN LOOSE LAYERS NO GREATER THAN 12 INCHES AND COMPACTED TO THE SATISFACTION OF THE OWNER. PLACE IN A MANNER WHICH DOES NOT DAMAGE OR DISPLACE WARNING TAPE OR ADJACENT
- 20. EMBEDMENT MATERIAL SHALL BE MOISTURE CONDITIONED (AS REQUIRED). EMBEDMENT MATERIAL SHALL BE PLACED TO THE DEPTH SHOWN ON THE DRAWINGS AND PLACED IN LOOSE LAYERS NO GREATER THAN 8 INCHES OR 3/4 OF THE PIPE DIAMETER (WHICHEVER IS SMALLER). COMPACT EMBEDMENT MATERIAL TO THE SATISFACTION OF THE OWNER.
- 21. COVER SOIL SHALL BE MOISTURE CONDITIONED (AS REQUIRED), PLACED IN LOOSE LAYERS NO GREATER THAN 12 INCHES AND COMPACTED TO THE SATISFACTION OF THE OWNER. PLACE IN MANNER WHICH DOES NOT DAMAGE ADJACENT INFRASTRUCTURE. COVER SOIL SHALL BE UNIFORMLY BACK BLADED TO THE FINISHED GROUND ELEVATIONS AND SHALL BE REASONABLY SMOOTH AND FREE OF IRREGULARITIES.

#### GENERAL SYMBOLOGY:

**PLAN** 

1/4" = 1'-0"

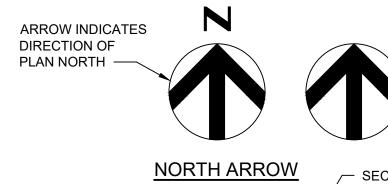

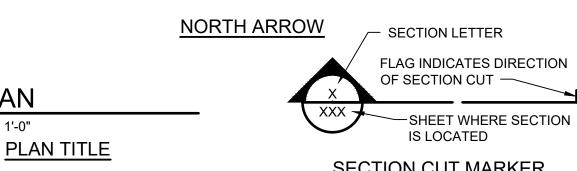

 SECTION LETTER **SECTION** SHEET WHERE SECTION VIEW IS FIRST CUT \* SECTION TITLE


# SECTION CUT MARKER DETAIL NUMBER

IS LOCATED \*

DETAIL TITLE

SHEET WHERE DETAIL

## CIVIL MAPPING SYMBOLOGY:

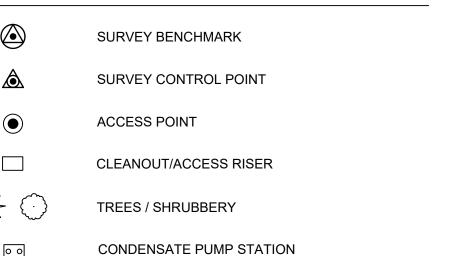

**GROUNDWATER MONITORING WELL DELINEATION WELL** BACKGROUND WELL

GROUNDWATER UNDERDRAIN

VALVE

 $\bowtie$ 

GAS EXTRACTION WELL (VERTICAL)

REDRILLED VERTICAL GAS EXTRACTION WELL

CONVERT TO REMOTE WELLHEAD

TIE-IN TO EXISTING LATERAL GAS MONITORING PROBE

**PIEZOMETER** 

LEACHATE MONITORING POINT

LEACHATE WELL

LEACHATE ACCESS STICK-UP

— C — CONDENSATE LINE


— GW———— GROUNDWATER PIPE

LEACHATE PIPE

----- COMPRESSED AIR LINE

— >>——— DRAINAGE TERRACE

## UTILITY/CIVIL LINE SYMBOLOGY:

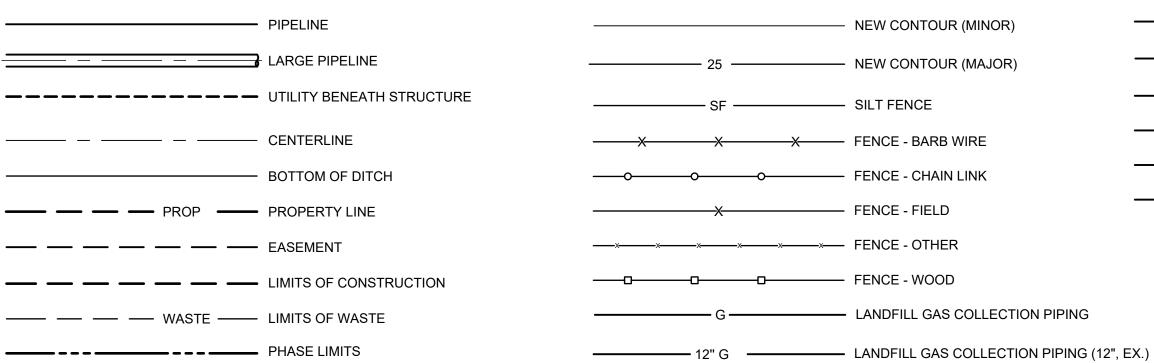

---- EXISTING CONTOUR (MINOR) - G-HZ ------ LANDFILL GAS HORIZONTAL COLLECTOR PIPING EXISTING CONTOUR W/ELEVATION (MAJOR) SANITARY SEWER **EXISTING FENCE** — STORM SEWER — DOMESTIC WATER EXISTING UNDERGROUND POWER — UGE —— NPW — DOMESTIC WATER NON-POTABLE **EXISTING OVERHEAD POWER LINE** — OHE ——

EXISTING LANDFILL GAS COLLECTION PIPING

### MATERIALS IN PLAN/SECTION:



— TD — TOE DRAIN

#### **EXISTING WELL SCHEDULE:**

WELL ID	NORTHING	EASTING	EXISTING ELEVATION <sup>1</sup>	ELEVATION WHEN DRILLED <sup>2</sup>
GW-1R	3502846	5448222	894.41	893.8
GW-2	3502915	5448334	890.39	893.0
GW-3	3502935	5448634	892.14	894.0
GW-4	3502895	5448835	886.94	888.0
GW-5	3502744	5448168	893.97	897.0
GW-6	3502723	5448465	905.00	908.0
GW-7	3502722	5448766	899.14	902.0
GW-8	3502479	5448092	874.87	876.0
GW-9	3502478	5448312	900.85	906.0
GW-10	3502476	5448610	909.13	910.0
GW-11	3502479	5448912	893.59	896.0
GW-12	3502252	5448208	877.10	874.0
GW-13	3502251	5448508	888.51	886.0
GW-14	3502257	5448809	900.39	895.0
GW-15	3502048	5448456	870.04	856.0
GW-16	3502006	5448648	907.87	887.0
GW-17	3502006	5448947	902.37	866.0
GW-18	3501773	5448484	874.47	868.0
GW-19	3501774	5448784	910.23	888.0
GW-21	3501527	5448445	862.03	857.0
GW-22	3501653	5448640	900.19	887.0
GW-23	3501318	5448525	880.33	858.0
GW-24	3501188	5448319	856.20	860.0
GW-25	3501209	5448576	876.62	860.0
GW-26	3501229	5448768	888.92	Х
GW-27	3500984	5448826	888.70	858.2
GW-29	3501297	5449197	889.93	879.5
GW-31	3501304	5449533	875.50	870.9
GW-32	3501030	5449585	871.88	872.9
GW-33	3500798	5449399	853.07	856.7
GW-34	3501025	5449318	885.98	873.0
GW-35	3500778	5449131	852.76	854.2
GW-36	3500755	5448901	849.79	853.2
GW-37	3500678	5448646	839.74	834.6
GW-38	3500698	5448423	840.82	835.0
GW-39	3500985	5448456	853.24	840.5

EXIST. HORIZONTAL COLLECTION WELLS			
GAS WELL NO.	NORTHING	EASTING	
GWH-1	3502911	5448129	
GWH-2	3502915	5448334	
GWH-3	3502935	5448634	
GWH-4	3502895	5448835	
GWH-5	3502744	5448168	
GWH-7	3502722	5448766	
GWH-10	3502476	5448610	
GWH-12	3502252	5448208	

#### NOTES:


- 1. EXISTING ELEVATIONS TAKEN FROM TOPOGRAPHY SURVEYED BY AEROVIEW DATED OCTOBER 16, 2023.
- 2. AS-BUILT ELEVATIONS FROM FOTH DESIGN DRAWINGS (2009,

2014) AND HDR AS-BUILT RECORD DRAWINGS (2020).

			PROJECT MANAGER	M.MAYS
			CIVIL	K. KINLEY
			CIVIL	B. BUNKER
			DRAWN BY	B. BUNKER
A	11/09/2023	ISSUED FOR CLIENT REVIEW		
В	11/22/2023	ISSUED FOR BID		
SUE	DATE	DESCRIPTION	PROJECT NUMBER	10383401





**CRLCSWA SITE 2 SANITARY LANDFILL** 2024 LANDFILL GAS SYSTEM IMPROVEMENTS **GENERAL NOTES, LEGEND, AND ABBREVIÁTIONS** 

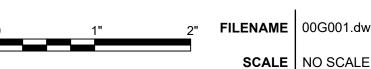

FILENAME | 00G001.dwg

SHEET 00G001

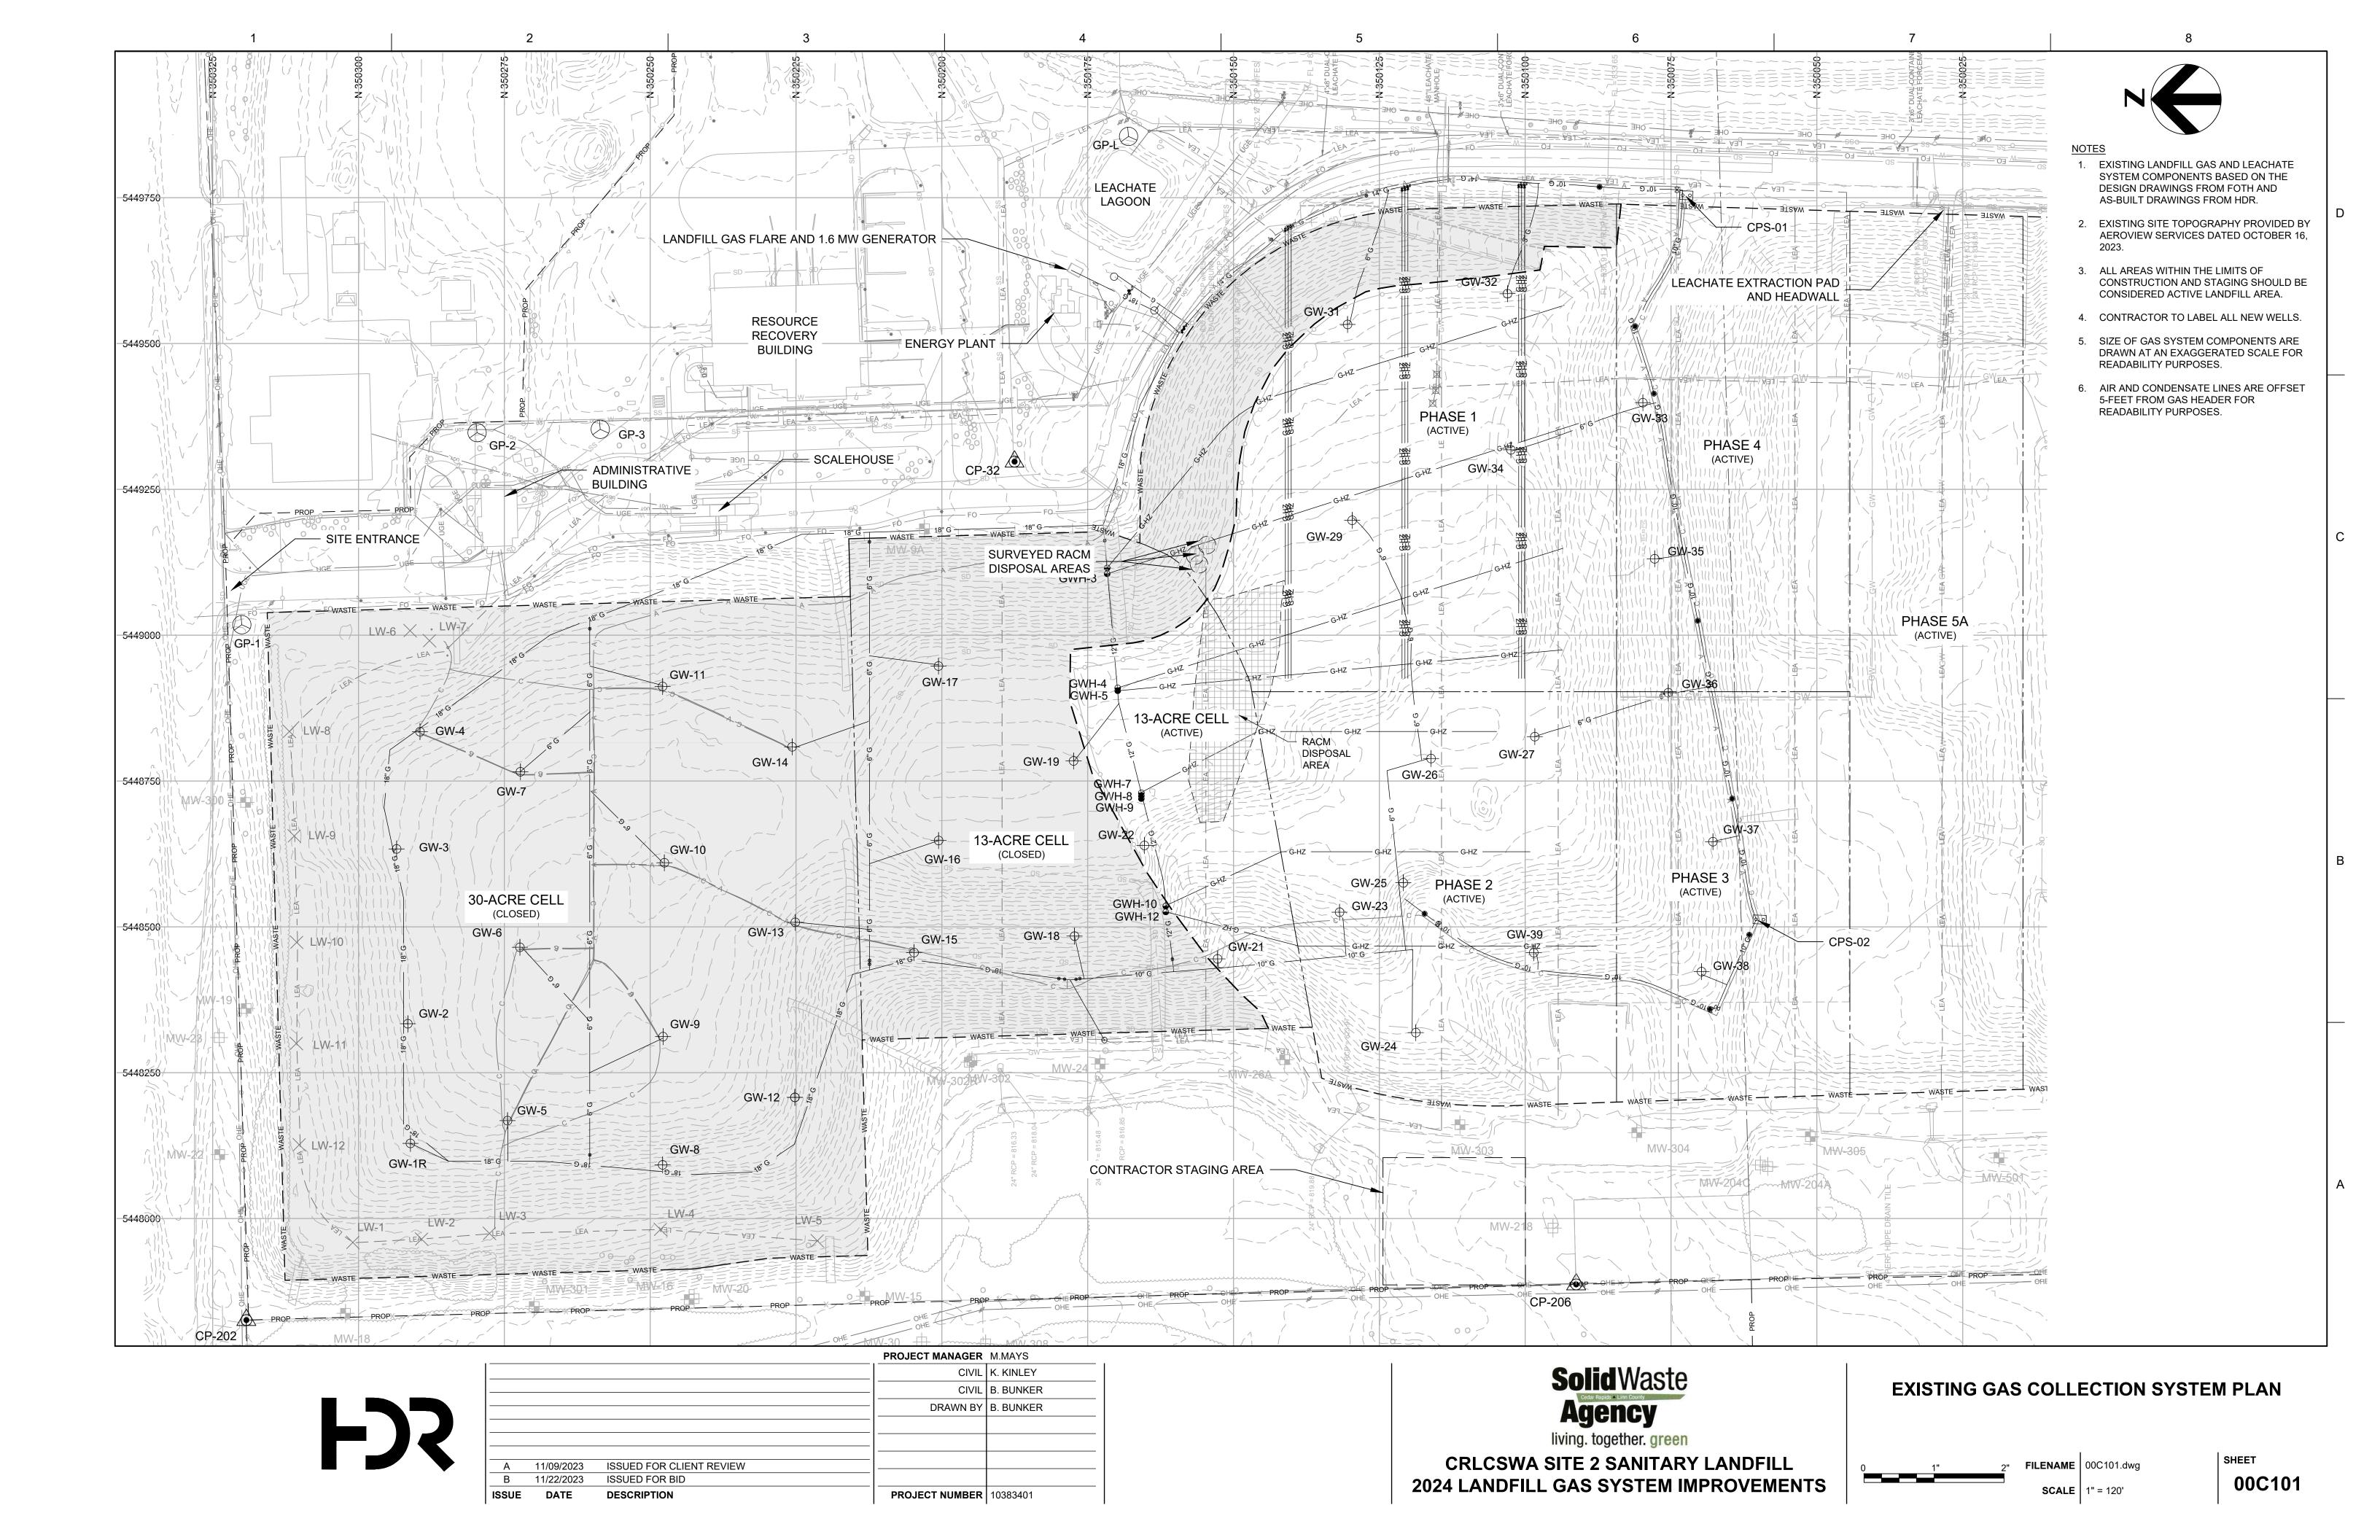

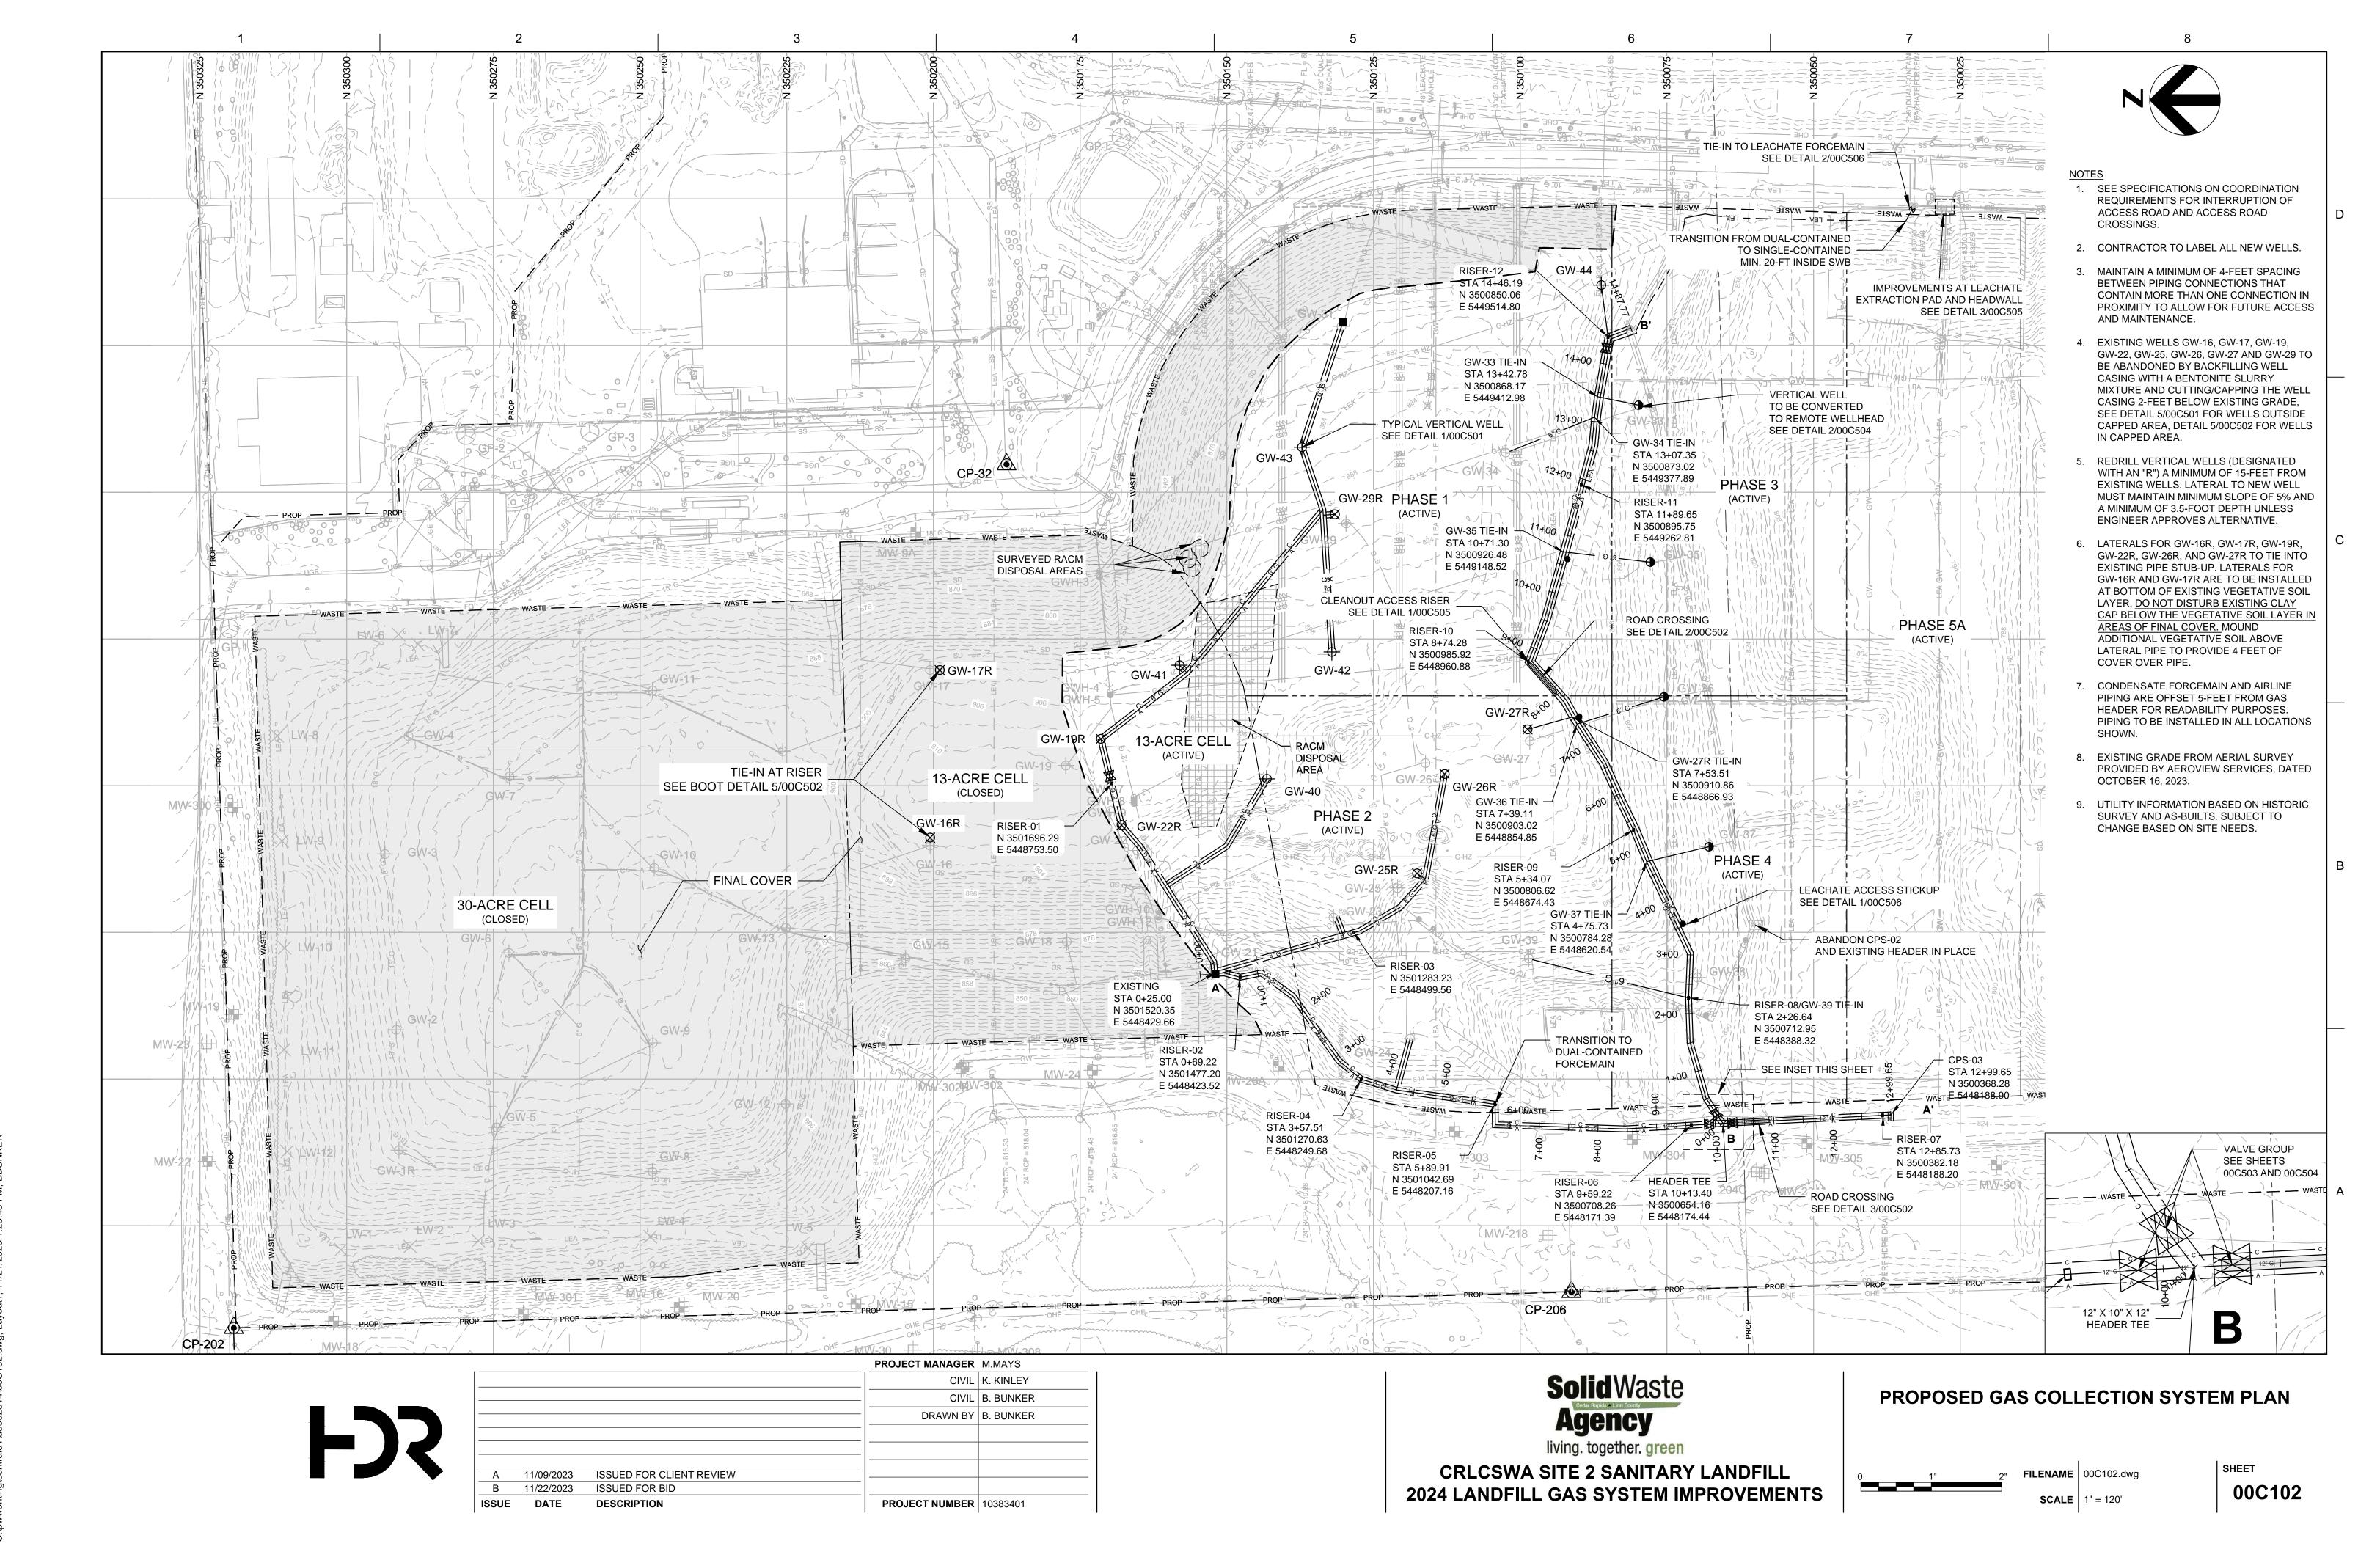

C:\pww.workipa\central01\d3992314\00C102 dwg | ayout1 11/21/2023 1:25:45 PM

HEADER-PR12 STA 6+01.32 ELEV 824.91 HEADER-PR07 STA 3+08.47 ELEV 838.31 HEADER-PRO RISER-04 STA 3+57.51 ELEV 840.00 HEADER-PR1 RISER-05 STA 5+89.91 ELEV 832.47 HEADER-PR16 HEADER TEE STA 10+13.40 (A-A') STA 0+00.00 (B-B') ELEV 821.65 HEADER-PR1 STA 0+52.00 ELEV 822.97 860 RISER-07 STA 12+85.73 ELEV 823.71 1. CONTRACTOR TO MAINTAIN A MINIMUM 5% 850 SLOPE FOR LANDFILL GAS HEADER PIPING LOCATED WITHIN THE SOLID WASTE BOUNDARY. 840 TIE-IN TO EXISTING EXISTING GRADE 12" SDR-17 HDPE PIPE PHASE 2 EXISTING 4" PVC 2. LANDFILL GAS HEADER PIPING TO BE PIPING ESTIMATED EL 850 3.00% (ACTIVE) WATER LINE -COVERED WITH A MINIMUM OF 3.5-FEET OF 830 PHASE 4 (ACTIVE) CLEAN SOIL BACKFILL. 820 820 EXISTING LINER 12" SDR-17 HDPE PIPE - ROAD CROSSING; ANCHOR TRENCH CROSSING; SEE DETAIL 3/00C502 SEE DETAIL 1/00C505 -CONNECTION TO HEADER
IN ALIGNMENT B-B' 800 800 1+00 1+50 2+00 2+50 3+00 3+50 4+00 5+00 6+00 6+50 7+00 7+50 8+00 8+50 9+00 9+50 10+00 10+50 11+00 11+50 12+00 12+50 13+00 LANDFILL GAS HEADER - ALIGNMENT A-A' HORIZ: 1" = 80' VERT: 1" = 20' 920 920 910 910 HEADER-PR32 RISER-11 STA 11+89.65 ELEV 871.58 HEADER-PR33 STA 12+60.21 ELEV 862.76 HEADER-PR27 STA 6+59.19 ELEV 869.92 900 900 HEADER-PR2 RISER-09 STA 5+34.07 ELEV 864.12 HEADER-PR24 STA 5+87.39 ELEV 864.20 HEADER-PR34 GW-34 TIE-IN STA 13+07.35 ELEV 858.75 890 890 880 880 HEADER-PR17 STA 0+16.79 ELEV 826.25 HEADER-PR18 STA 0+52.13 ELEV 828.01 ROAD CROSSING; 870 EXISTING GRADE (10-16-2023) SEE DETAIL 3/00C502 860 10" SDR-17 HDPE PIPE — 4.67% 3.54% 850 TIE-IN TO EXISTING
PIPING ESTIMATED EL 852 840 830 830 PHASE 3 (ACTIVE) PHASE 4 PHASE 1 PHASE 3 (ACTIVE) 820 (ACTIVE) (ACTIVE) 820 ANCHOR TRENCH CROSSING; 810 810 SEE DETAIL 1/00C505 ─ EXISTING 4" \` 800 800 PVC WATER CONNECTION TO EXISTING LINER 790 790 HEADER IN ALIGNMENT A-A' 780 780 770 770 760 760 1+00 1+50 2+00 2+50 3+00 3+50 4+00 4+50 5+00 5+50 6+00 6+50 7+00 7+50 8+00 8+50 9+00 9+50 10+00 10+50 11+00 11+50 12+00 12+50 13+00 13+50 14+00 14+50 15+00 LANDFILL GAS HEADER - ALIGNMENT B-B' VERT: 1" = 20' PROJECT MANAGER M.MAYS **Solid** Waste CIVIL K. KINLEY PROPOSED GAS COLLECTION HEADER PROFILE CIVIL B. BUNKER DRAWN BY B. BUNKER living. together. green **CRLCSWA SITE 2 SANITARY LANDFILL** SHEET FILENAME 00C103.dwg 11/09/2023 ISSUED FOR CLIENT REVIEW

2024 LANDFILL GAS SYSTEM IMPROVEMENTS

11/22/2023

DATE


ISSUED FOR BID

**DESCRIPTION** 

PROJECT NUMBER | 10383401

00C103

SCALE AS SHOWN

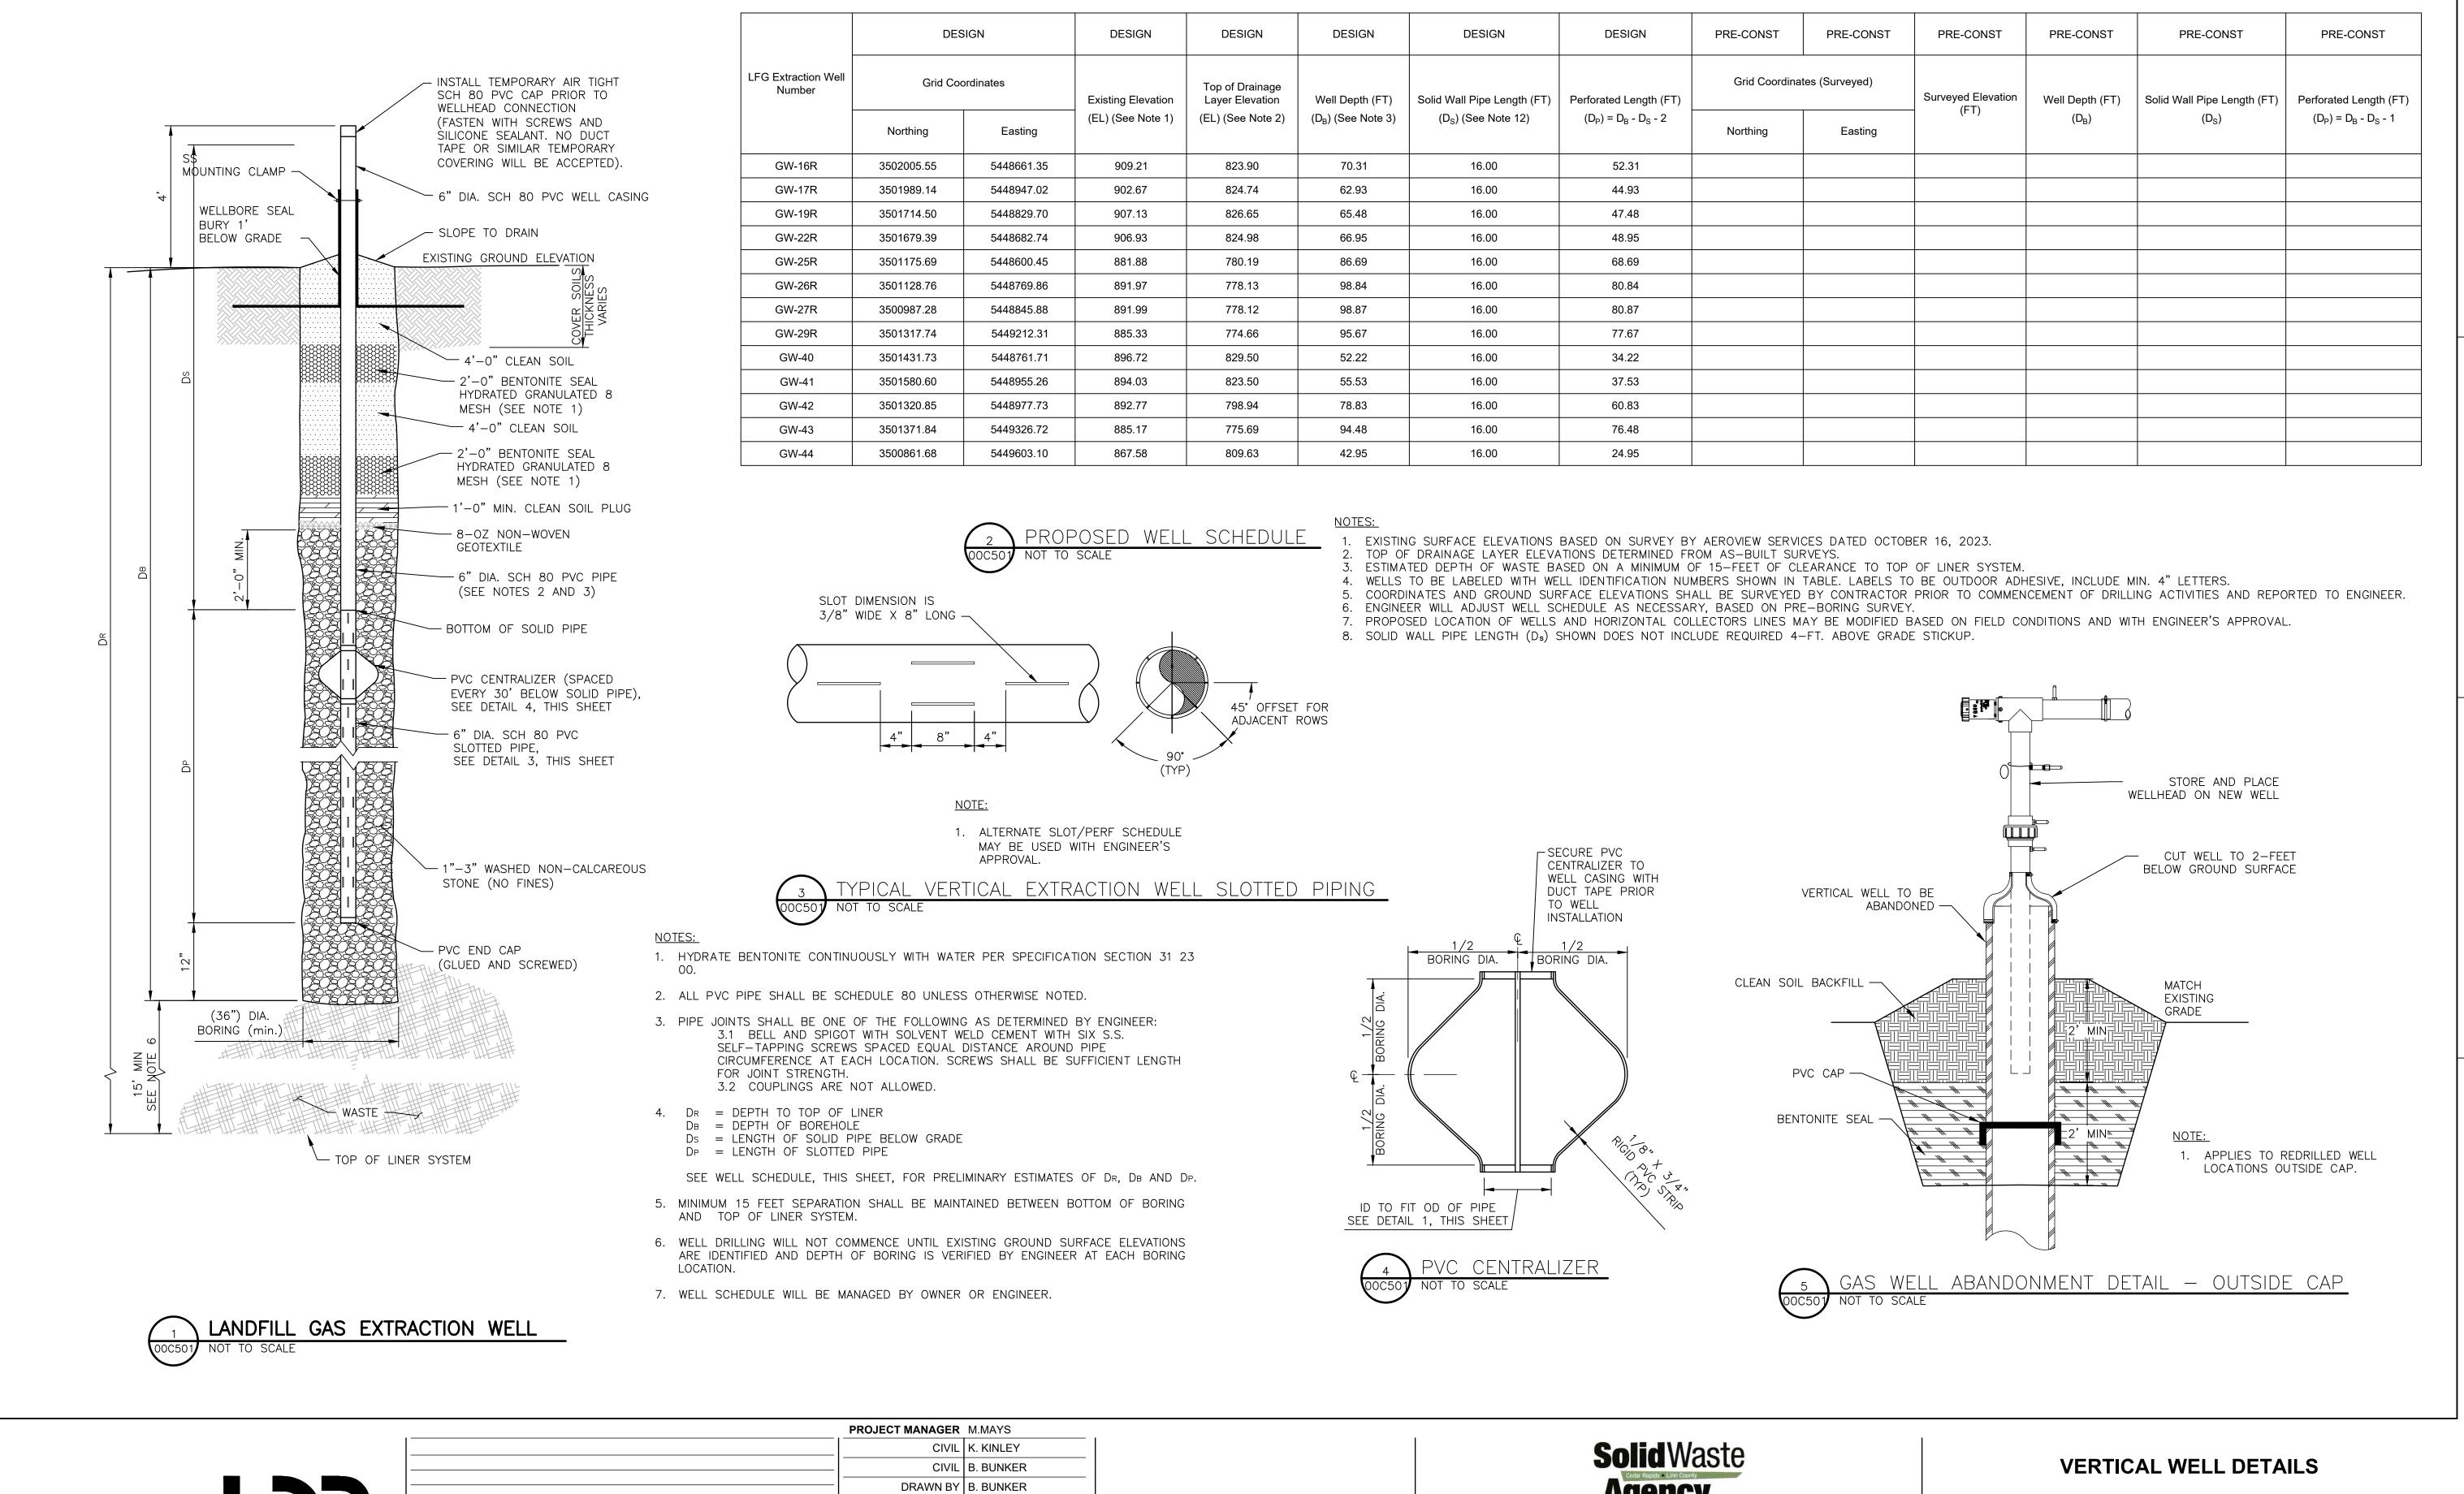

F)S


			CIVIL	K. KINLEY
l ———			CIVIL	B. BUNKER
			DRAWN BY	B. BUNKER
l —	44/00/0000	IOOUED FOR OUTENT DEVIEW		
<u> </u>	11/09/2023	ISSUED FOR CLIENT REVIEW		
B	11/22/2023	ISSUED FOR BID		
ISSUE	DATE	DESCRIPTION	PROJECT NUMBER	10383401
ı			1	I


living. together. green

**CRLCSWA SITE 2 SANITARY LANDFILL** 2024 LANDFILL GAS SYSTEM IMPROVEMENTS



SHEET 00C501

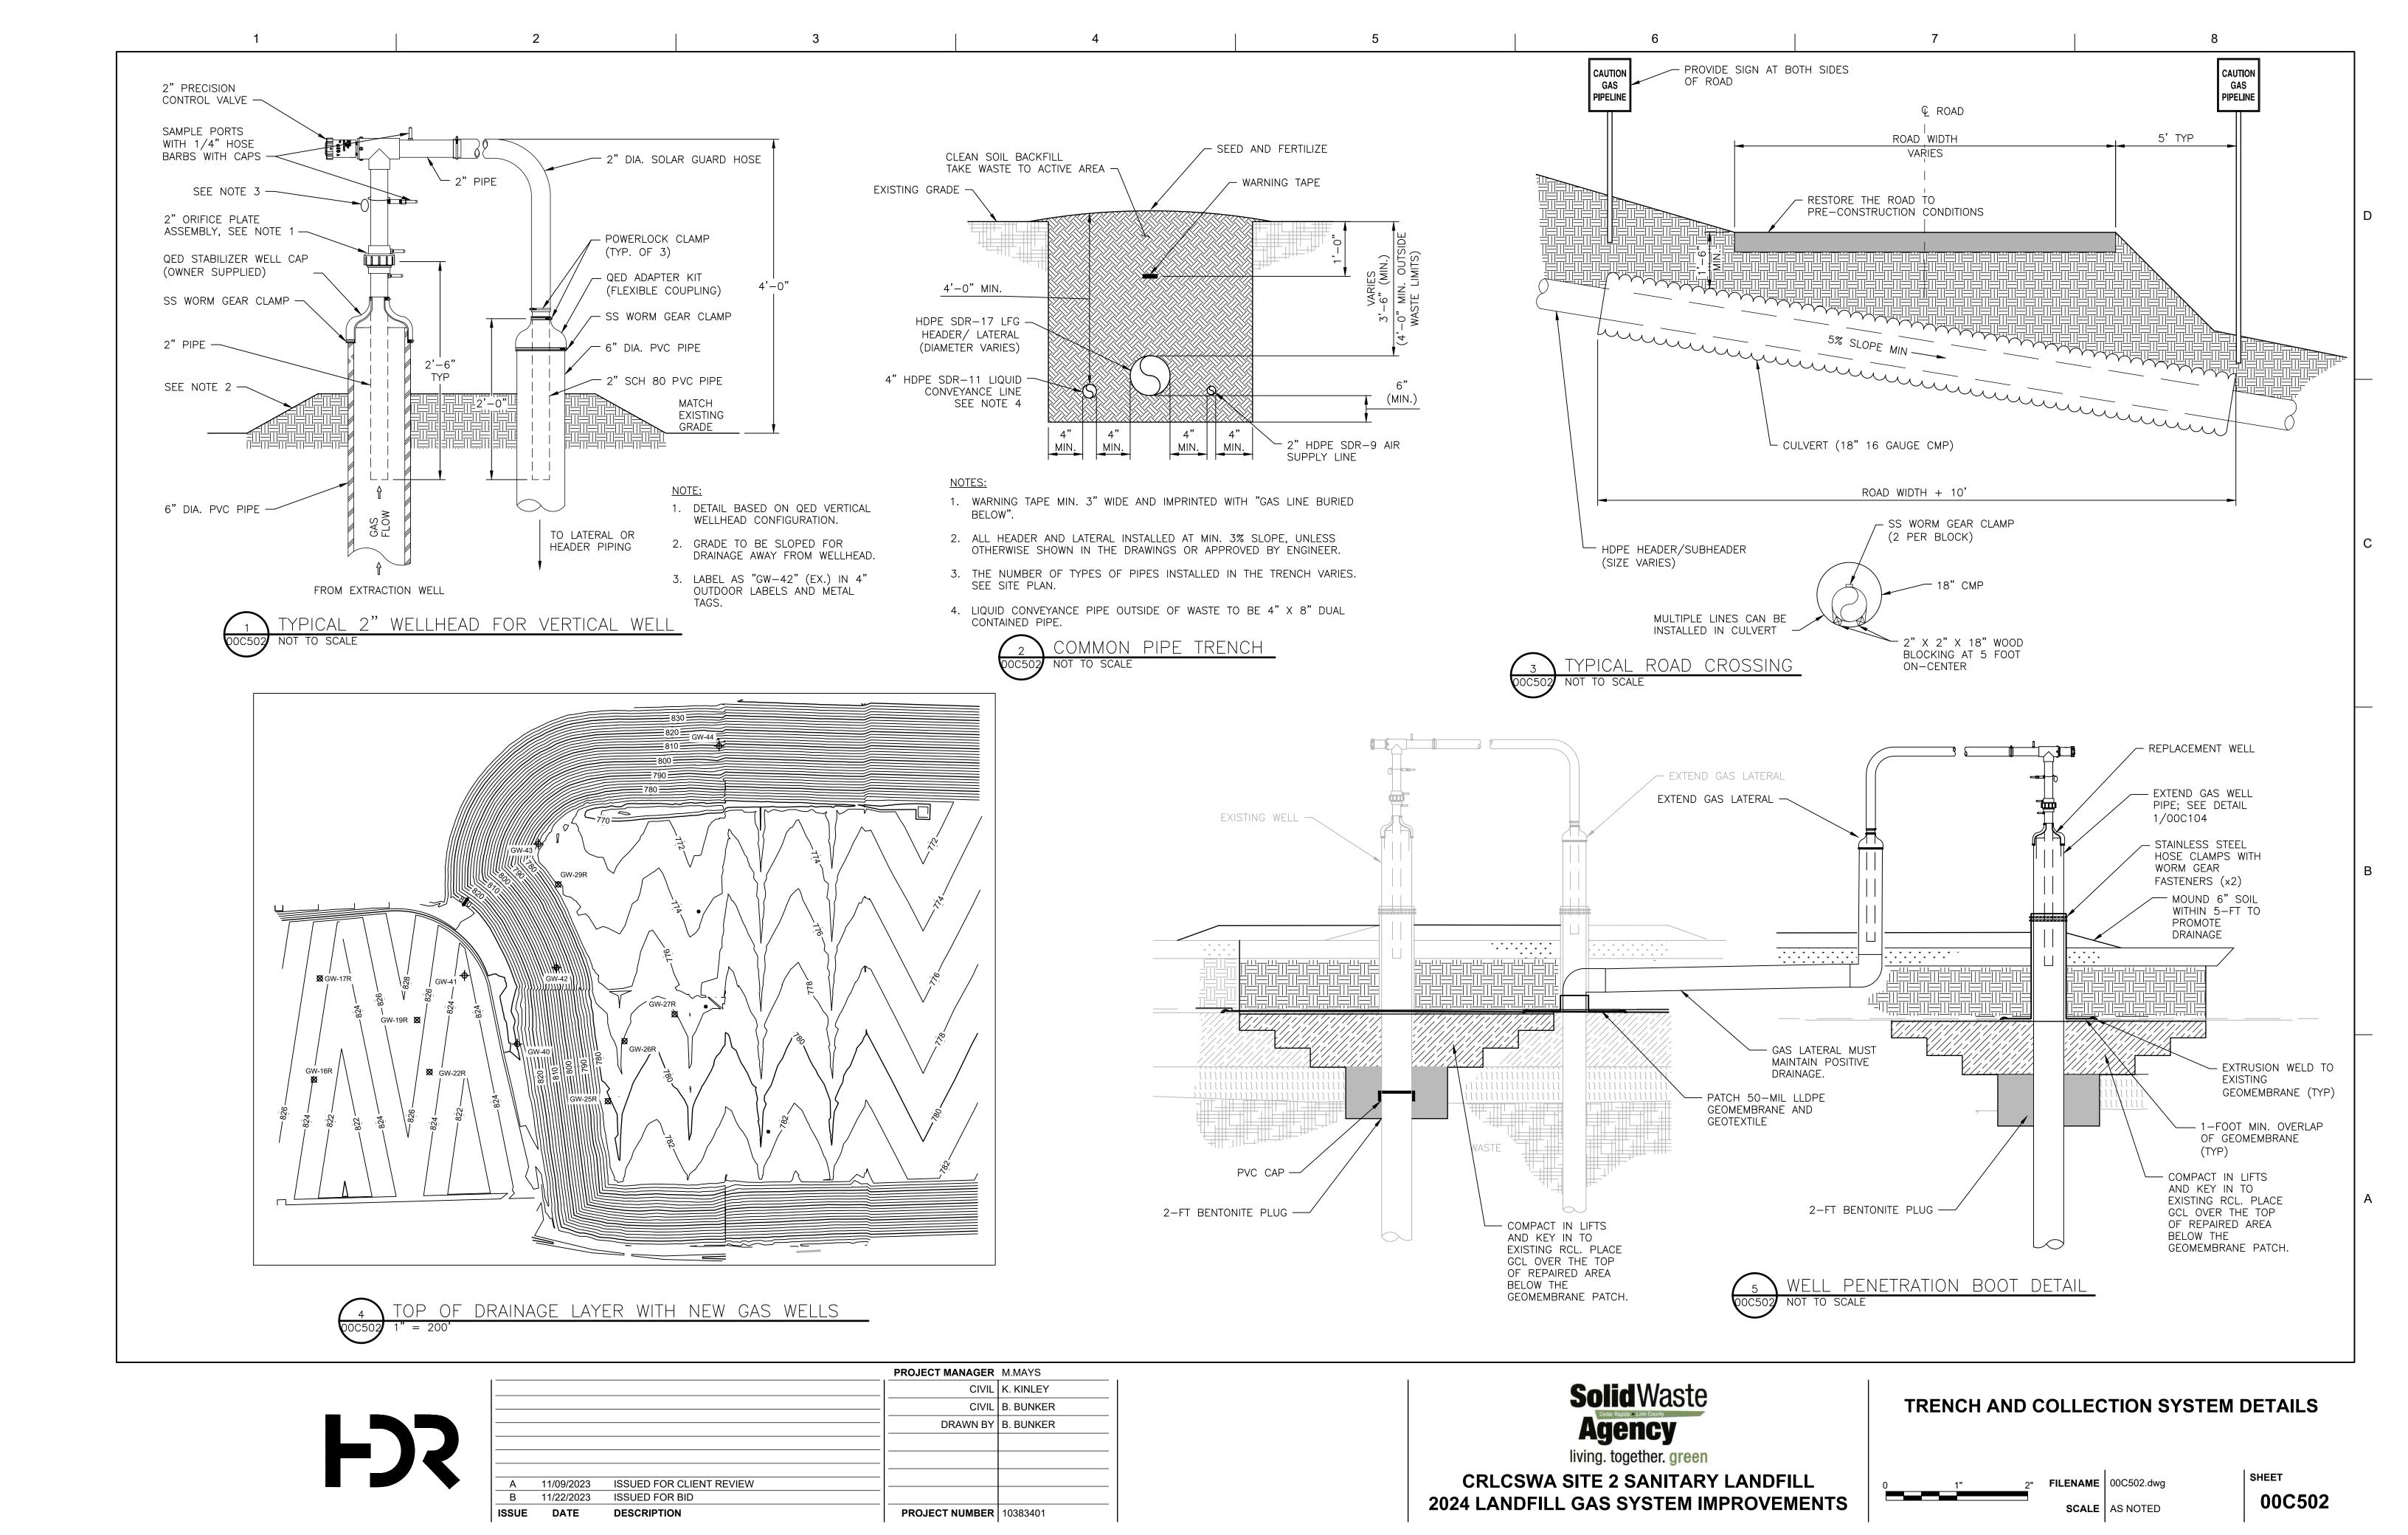

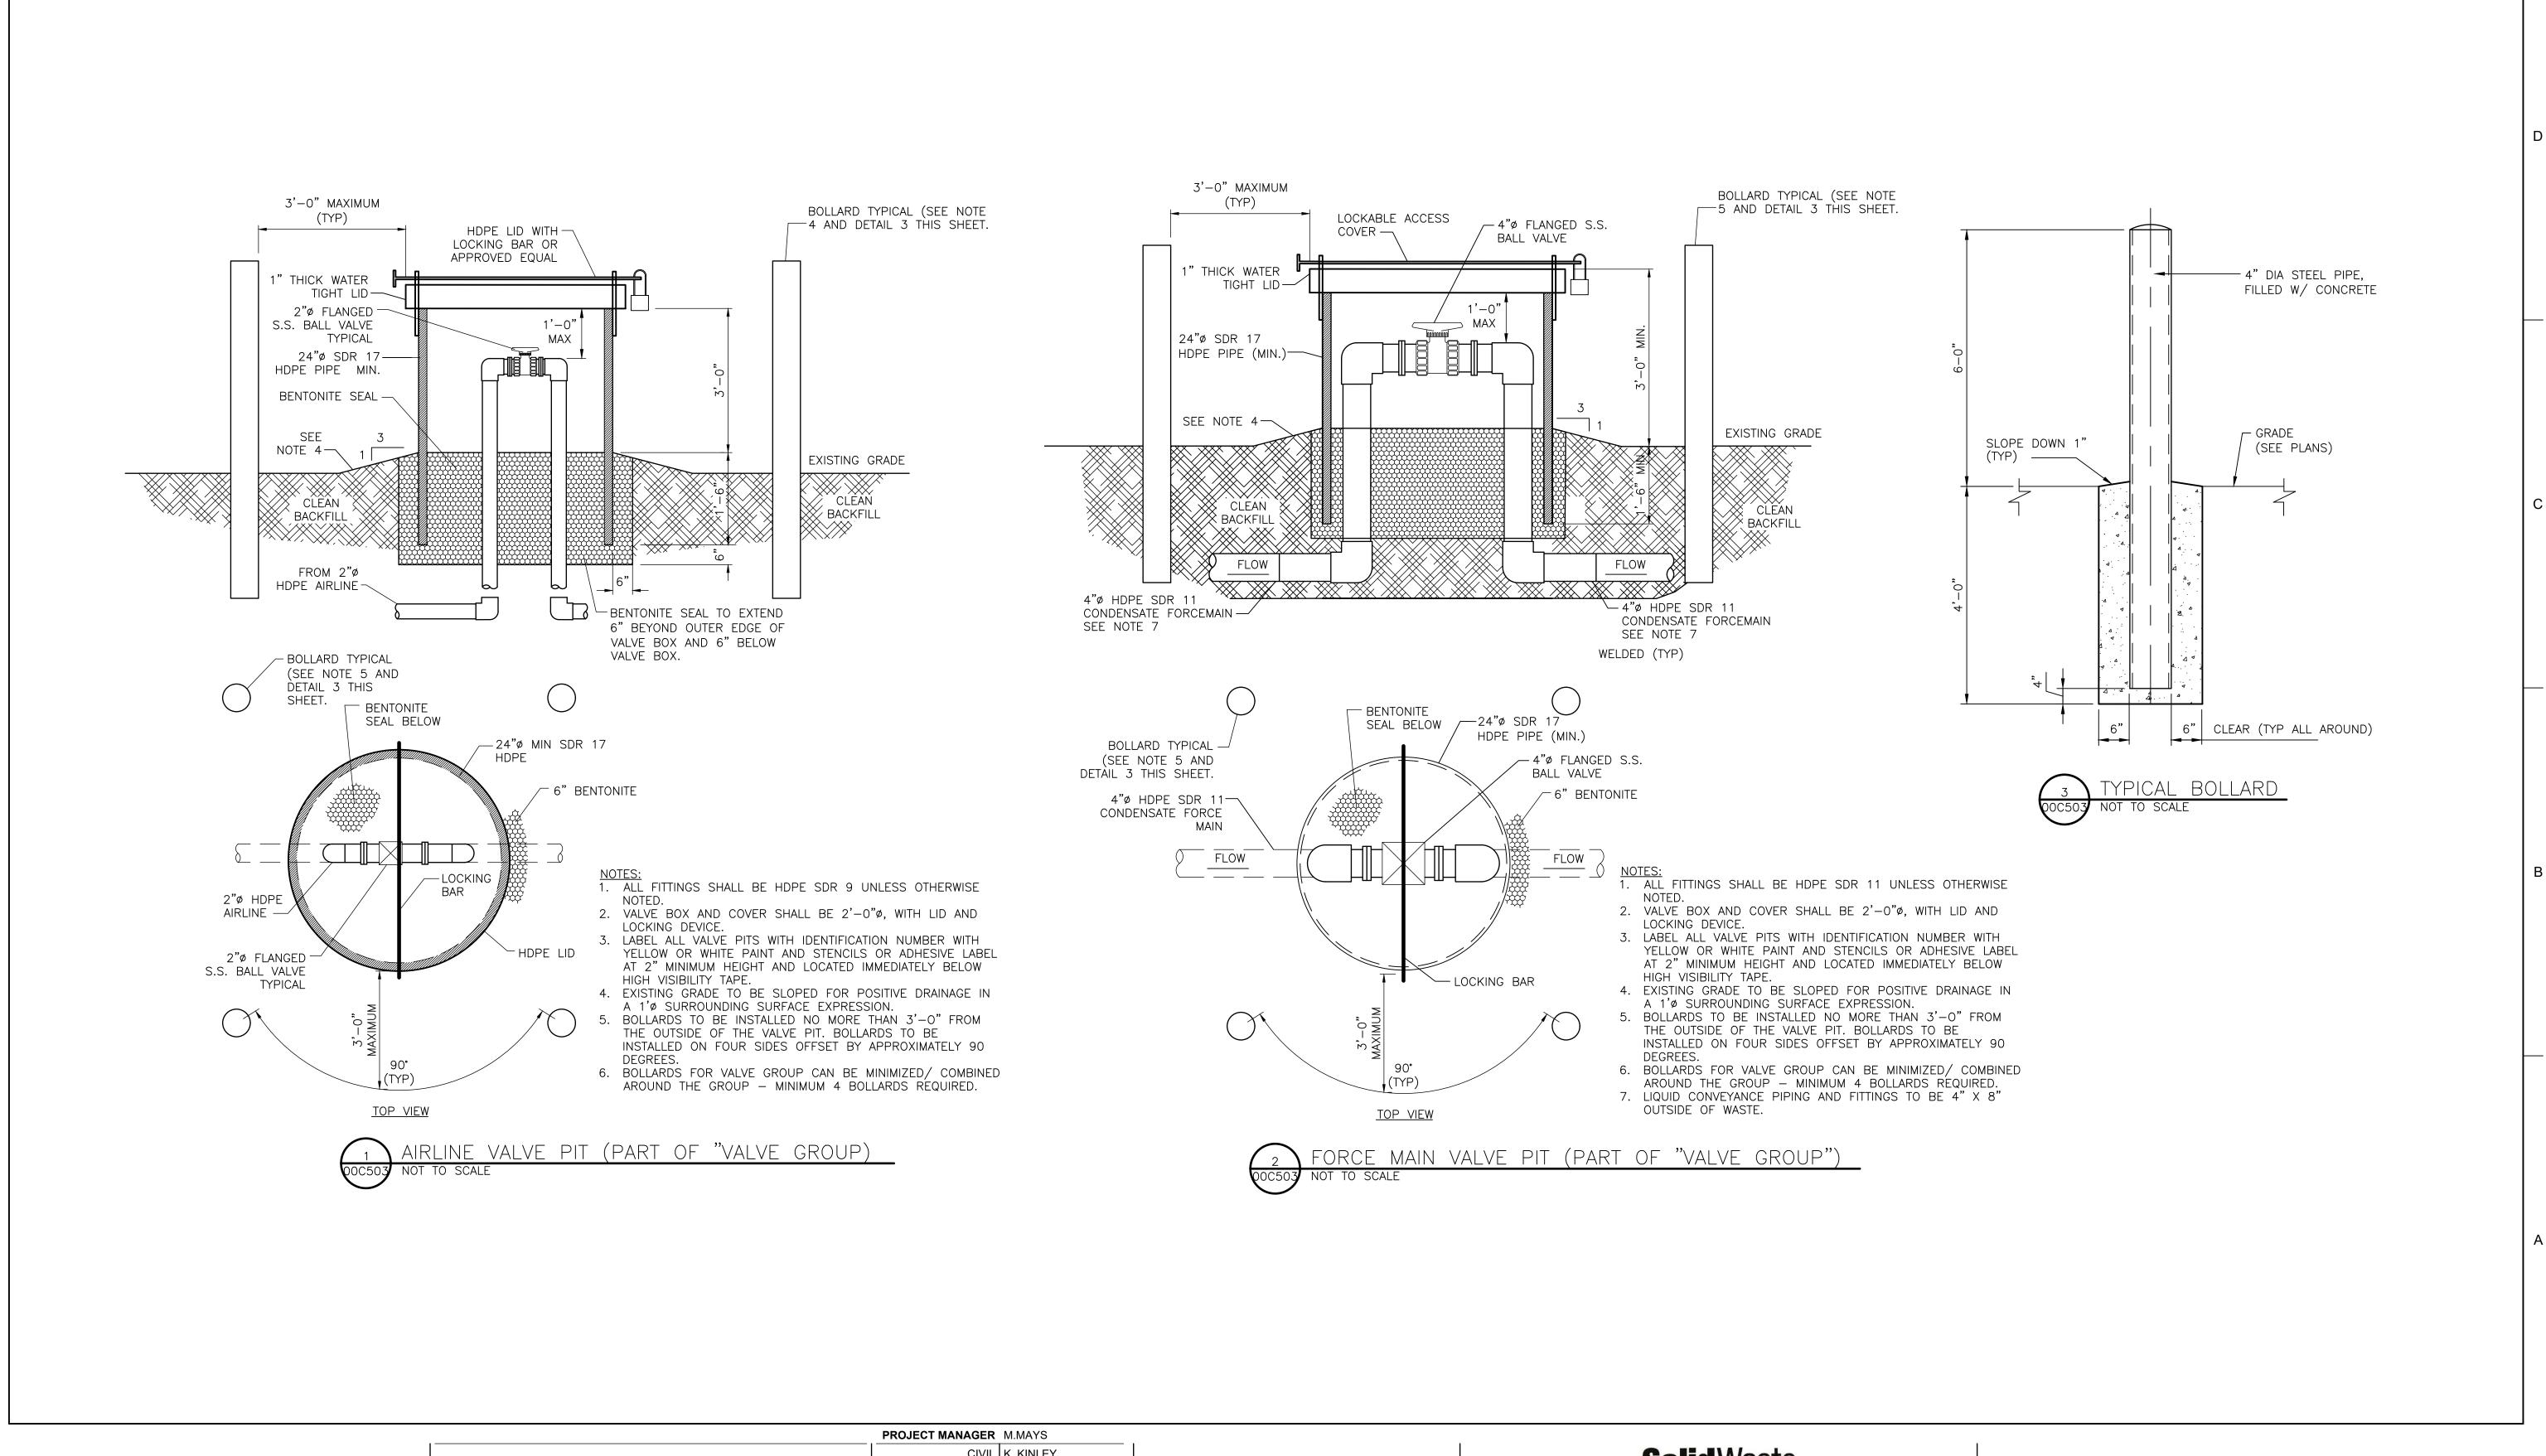

CIVIL K. KINLEY CIVIL B. BUNKER DRAWN BY | B. BUNKER 11/09/2023 ISSUED FOR CLIENT REVIEW 11/22/2023 ISSUED FOR BID PROJECT NUMBER | 10383401 DATE DESCRIPTION

# **Solid** Waste

living. together. green


**CRLCSWA SITE 2 SANITARY LANDFILL** 2024 LANDFILL GAS SYSTEM IMPROVEMENTS



**VALVE GROUP DETAILS** 


SHEET

00C503

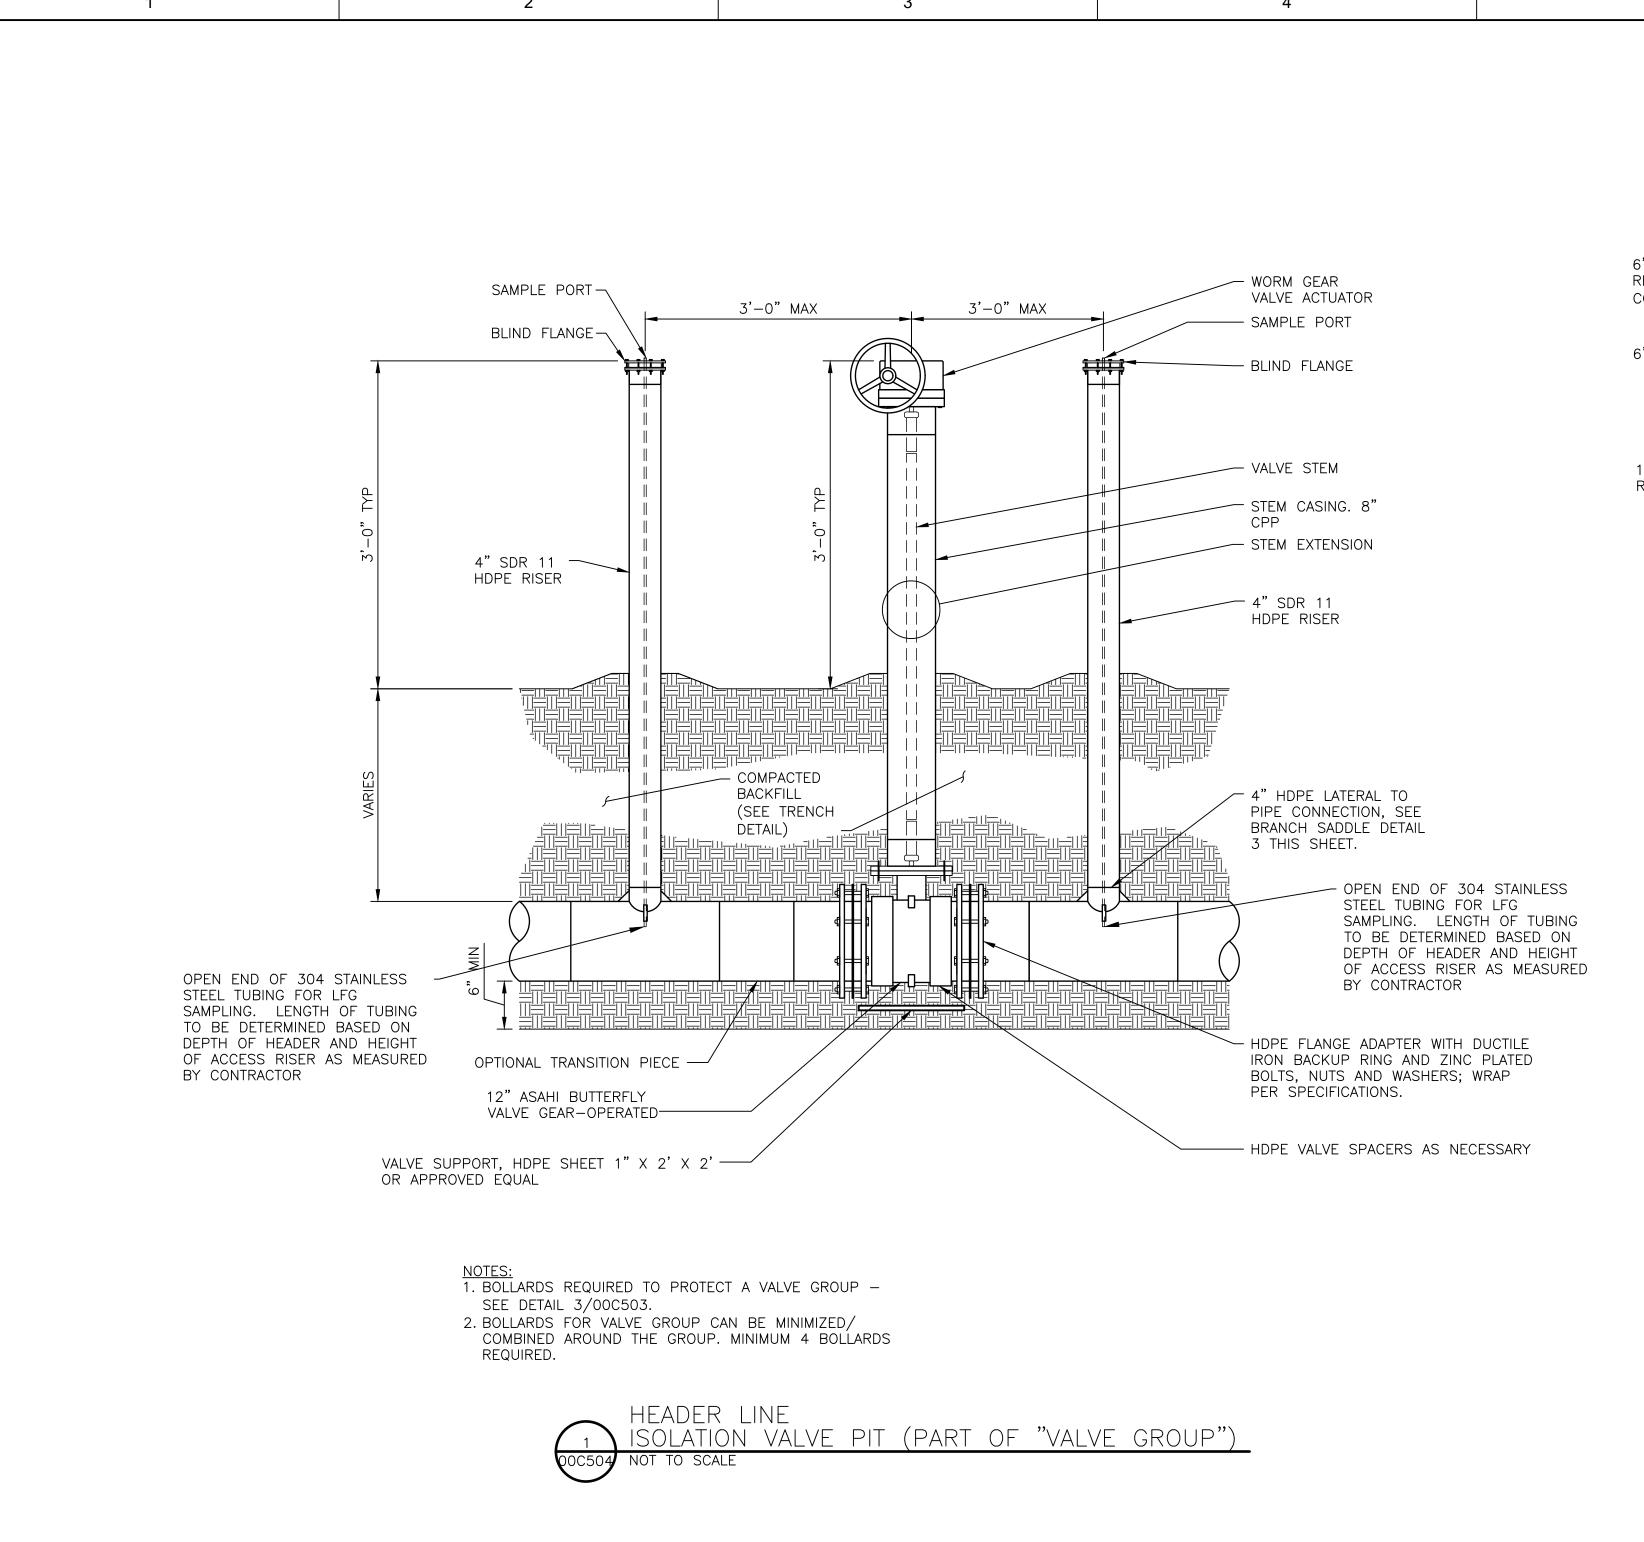

- EXISTING WELLHEAD ASSEMBLY (REMOVE AND REINSTALL) 6" X 2" FLEXIBLE REDUCING COUPLING (TYP) - PVC CAP 6" HDPE PIPE ─ - GROUND SURFACE 6" HDPE PIPE GROUND SURFACE 12" X 6" HDPE LEAVE EXISTING WELL REDUCING TEE -STUB UP (4') FOR FUTURE ACCESS 6" HDPE PIPE 10" HDPE GAS HEADER 6" SCH 80 PVC TO 6" HDPE TRANSITION 8" TEE WITH 6" 6" HDPE 90° ELBOW — REDUCER - EXISTING 8" SCH 80 PVC EXTRACTION WELL CASING

2 CONVERT TO REMOTE WELLHEAD 00C504 NOT TO SCALE

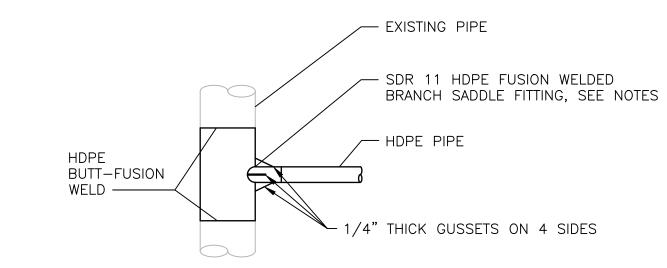

#### NOTES:

WELLHEAD ASSEMBLY

- 1. HDPE BRANCH SADDLE FITTINGS SHALL BE USED TO TIE—IN 2" DIA. AND LARGER PIPES TO 10" DIA. AND LARGER HEADER.
- 2. BRANCH SADDLE SHALL BE SHOP-FABRICATED. INSTALL TO MAINTAIN EXISTING SLOPE.
- 3. HDPE SUPPORT GUSSETS (LOCATED AT 0, 90, 180, & 270 DEGREES) ARE REQUIRED FOR BRANCH SADDLE FITTINGS.

PIPE CONNECTION WITH BRANCH SADDLE POC504 NOT TO SCALE

			CIVIL	K. KINLEY
			CIVIL	B. BUNKER
			DRAWN BY	B. BUNKER
Α	11/09/2023	ISSUED FOR CLIENT REVIEW		
В	11/22/2023	ISSUED FOR BID		
ISSUE	DATE	DESCRIPTION	PROJECT NUMBER	10383401

Solid Waste Agency

living. together. green

CRLCSWA SITE 2 SANITARY LANDFILL
2024 LANDFILL GAS SYSTEM IMPROVEMENTS

VALVE GROUP AND WELLHEAD DETAILS





VERTICAL EXTRACTION WELL

2" FILENAME 00C504.dwg


SCALE AS NOTED

00C504

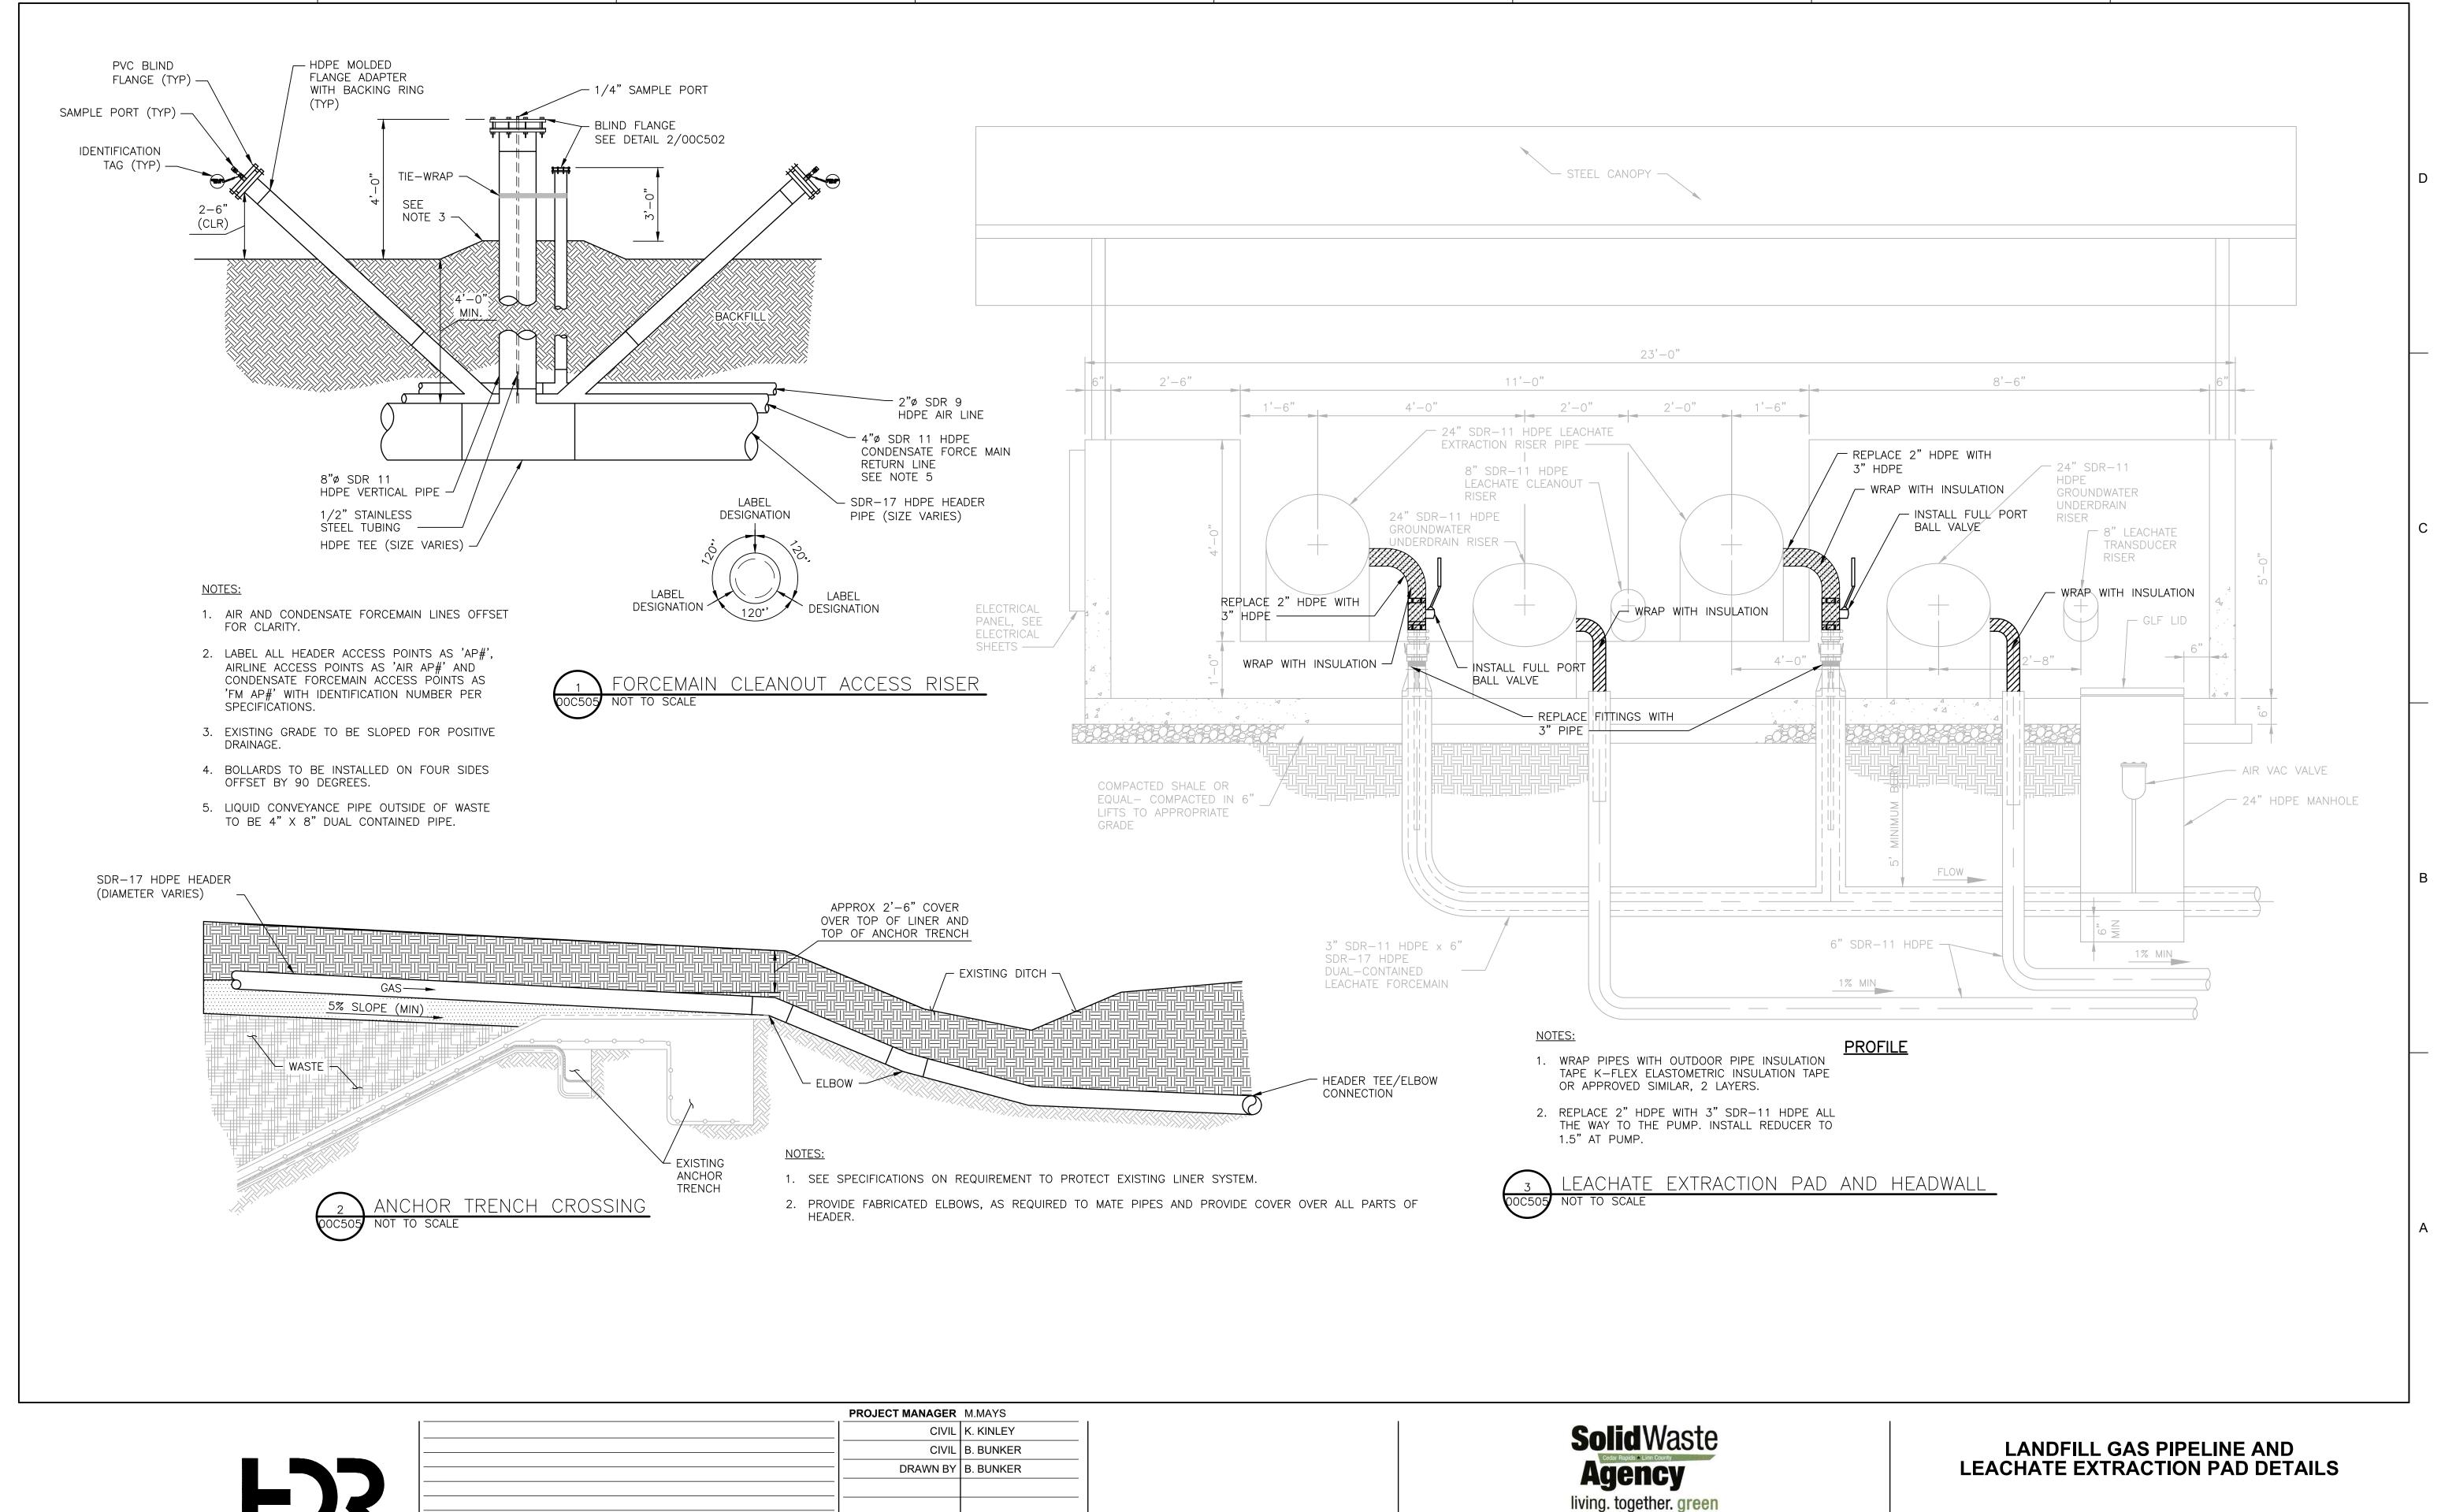


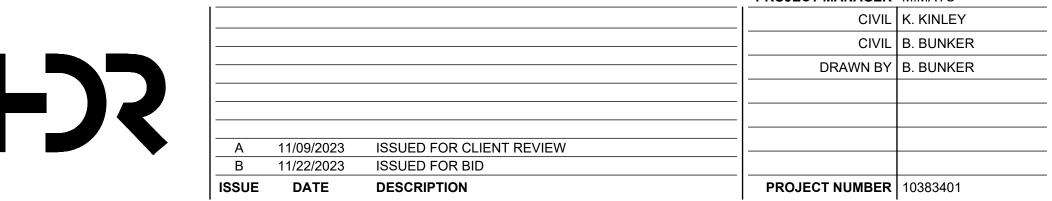

**CRLCSWA SITE 2 SANITARY LANDFILL** 2024 LANDFILL GAS SYSTEM IMPROVEMENTS

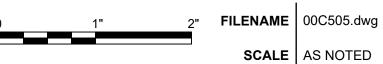

SHEET 00C505

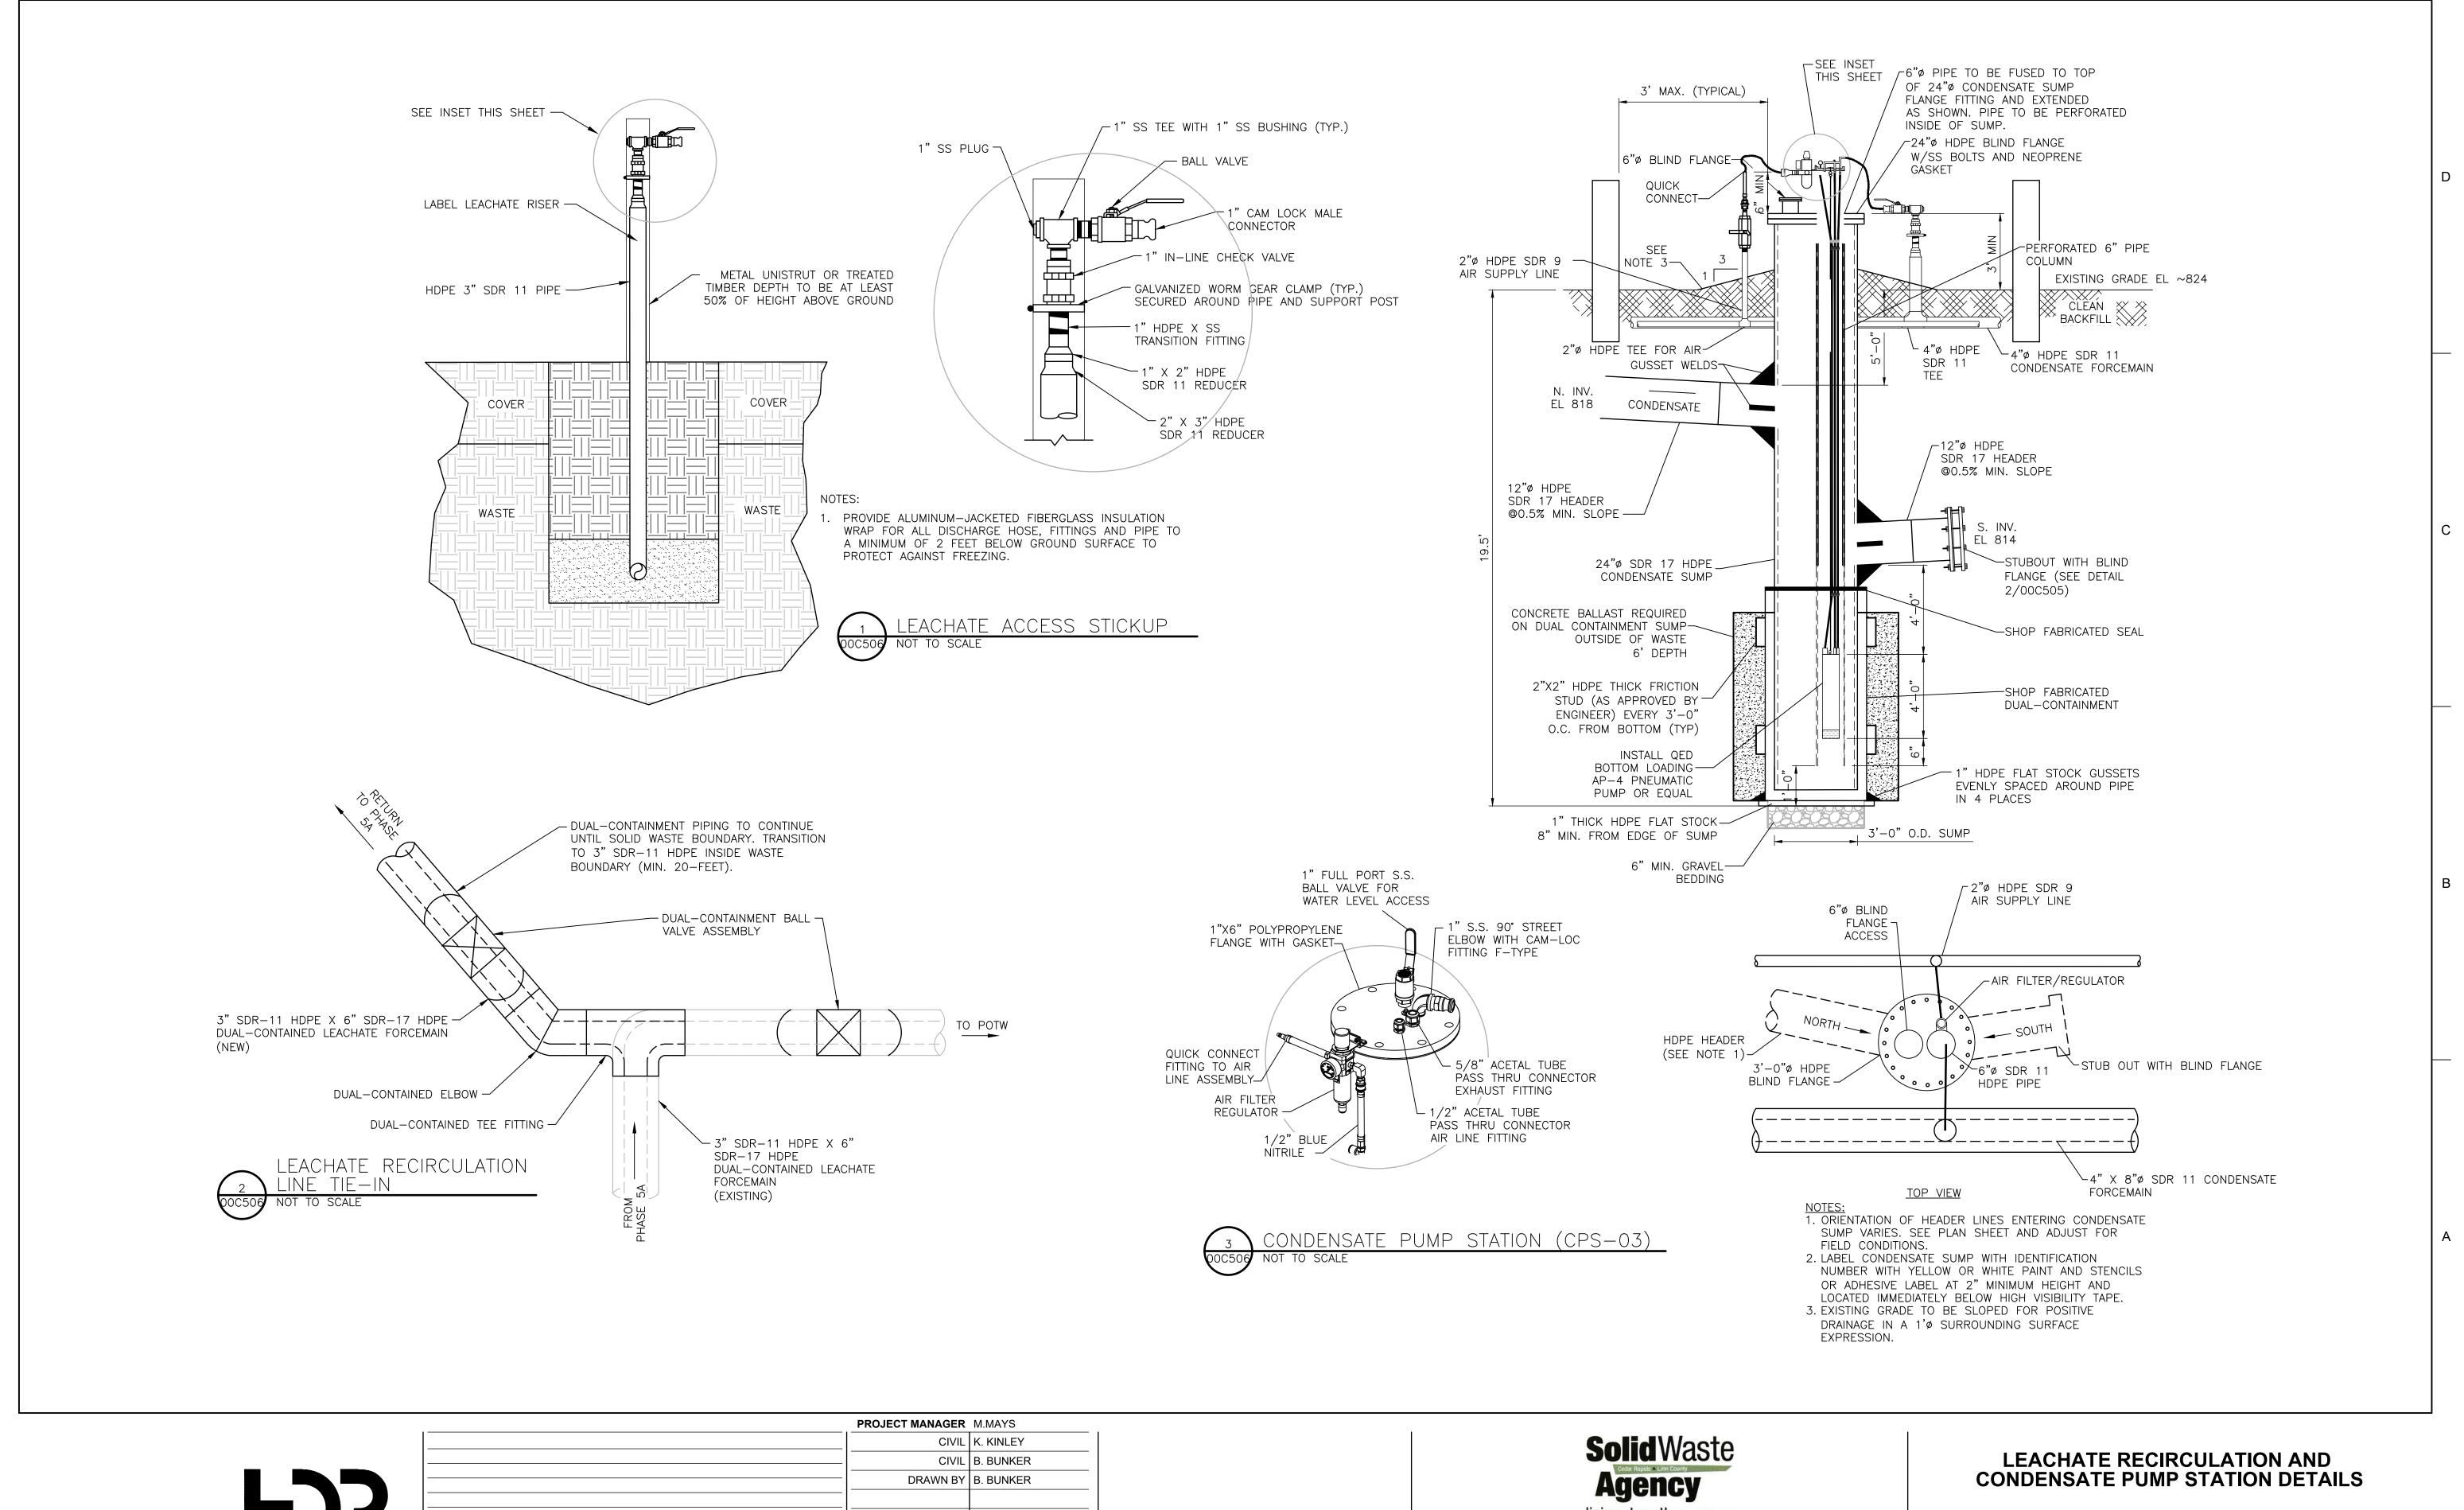



			- I KOOLOT MANAGEK	101.101/ (1 0
			CIVIL	K. KINLEY
			CIVIL	B. BUNKER
			DRAWN BY	B. BUNKER
A	11/09/2023	ISSUED FOR CLIENT REVIEW		
В	11/22/2023	ISSUED FOR BID		
ISSUE	DATE	DESCRIPTION	PROJECT NUMBER	10383401



**CRLCSWA SITE 2 SANITARY LANDFILL** 2024 LANDFILL GAS SYSTEM IMPROVEMENTS



SHEET 00C506